ELECTRICAL SYMBOL LIST

NOTE: This is a standard symbol list and not all items listed may be used.

Abbreviations

(E)	EXISTING
Α	AMPERES, AMBER
AIC	AVAILABLE INTERRUPTING CAPACITY
WG	AMERICAN WIRE GAUGE
С	CONDUIT, CLOSE, CONTROL
СВ	CIRCUIT BREAKER
CLG	CEILING
ORD	COORDINATE
CU	COPPER
DIM	DIMENSION
WG	DRAWING
EA	EACH
EL	ELEVATION
FT	FOOT, FEET
GND	GROUND
FCI	GROUND FAULT CIRCUIT INTERRUPTER
GFI	GROUND FAULT INTERRUPTER
HT	HEIGHT
IN	INCH, INCHES
(VA	KILOVOLT AMPERES
< W	KILOWATT
.ED	LIGHT EMITTING DIODE
ΛIN	MINIMUM
, MTD	MOUNT, MOUNTED
N/A	NOT APPLICABLE
IEC	NATIONAL ELECTRIC CODE
EMA	NATIONAL ELECTRICAL MANUFACTURERS ASSOCIATION
ITS	NOT TO SCALE
C	ON CENTER
EQD	REQUIRED
RM	ROOM
S	SWITCH
SHT	SHEET
ΥP	TYPICAL
UI	UNDERWRITERS LABORATORIES

UNDERWRITERS LABORATORIES

UNLESS OTHERWISE NOTED

VOLTS, VOLTAGE

WITHOUT

Connections / Equipment

① OR IJ	JUNCTION BOX
9	WALL-MOUNTED JUNCTION BOX

General

 ××	DEMOLISH
	EXISTING WORK
	NEW WORK
$\begin{pmatrix} x \\ x \end{pmatrix}$	DETAIL NUMBER AND SHEET LOCATION
1	KEYED NOTE

Misce	<u>llaneous</u>
#10 	BRANCH CIRCUIT WIRING. ARROW INDICATES HOME RUN TO PANEL WITH CIRCUITS AS NOTED. WIRE SIZE IS #12 AWG MINIMUM UNLESS NOTED OTHERWISE. SHORT TICK MARKS INDICATE PHASE CONDUCTORS. LONG TICK MARKS INDICATE NEUTRAL CONDUCTORS. A SINGLE CURVED TICK MARK INDICATES INSULATED GREEN GROUND CONDUCTOR. SECOND CURVED TICK MARK INDICATES "ISOLATED GROUND" (GREEN INSULATION WITH YELLOW STRIPE) CONDUCTOR.

BRANCH PANEL

<u> </u>	FLUSH WALL MOUNTED BRANCH PANEL
- - ı	GROUNDING POINT

Raceways

	<u></u>
	CONDUIT CONCEALED IN WALL OR CEILING SPACE
	CONDUIT ROUTED BELOW FLOOR / GRADE
<u></u>	CONDUIT/WIRING CONTINUATION
	CONDUIT/WIRING STUBBED OUT WITH END CAP OR INSULATED PLASTIBUSHING

Switches and Receptacles

SPECIAL PURPOSE RECEPTACLE. LETTER CODE DENOTES RECEPTACLE CONFIGURATION

> LX-XXR = NEMA CONFIGURATION TWIST-LOCK RECEPTACLE X-XXR = NEMA CONFIGURATION STRAIGHT BLADE RECEPTACLE P = PENDANT MOUNT WITH CORD GRIPS. VERIFY PENDANT LENGTH X = COORDINATE RECEPTACLE CONFIGURATION WITH EQUIPMENT BEING SUPPLIED

GENERAL ELECTRICAL NOTES

- A. DO NOT COMMENCE INSTALLATION OF ELECTRICAL SYSTEMS AND EQUIPMENT WITHOUT RELATED SHOP DRAWING APPROVALS.
- B. ELECTRICAL CIRCUITS SHALL BE INTERRUPTED ONLY WITH PRIOR WRITTEN CONSENT. SUCH INTERRUPTIONS SHALL BE PRECEDED BY ALL POSSIBLE PREPARATIONS BY THE CONTRACTOR WHICH ARE NECESSARY TO KEEP THE ELECTRICAL CIRCUITS OFF FOR A MINIMUM PERIOD IN AN EXPEDITIOUS MANNER PURSUANT WITH GOOD WORKMANSHIP. THIS INCLUDES CIRCUIT TRACING TO IDENTIFY THE ELECTRICAL LOAD BEING SERVED AND THE ORIGIN OF THE CIRCUIT.
- COORDINATE WITH OWNER SO THAT WORK CAN BE SCHEDULED NOT TO INTERRUPT OPERATIONS, NORMAL ACTIVITIES, BUILDING ACCESS, ACCESS TO DIFFERENT AREAS. THE OWNER WILL COOPERATE TO THE BEST OF THEIR ABILITY TO ASSIST IN A COORDINATED SCHEDULE, BUT WILL REMAIN THE FINAL AUTHORITY AS TO TIME OF WORK PERMITTED.
- D. COORDINATE THE EXACT LOCATION OF EXISTING UTILITIES AND EQUIPMENT PRIOR TO COMMENCEMENT OF WORK. COMPENSATE THE OWNER FOR DAMAGES CAUSED BY THE FAILURE TO LOCATE AND PRESERVE UTILITIES. REPLACE DAMAGED ITEMS WITH NEW MATERIAL TO MATCH EXISTING.
- REMOVE EXISTING LUMINAIRES, SWITCHES, RECEPTACLES, AND OTHER ELECTRICAL EQUIPMENT AND DEVICES AND ASSOCIATED WIRING FROM WALLS, CEILINGS, FLOORS, AND OTHER SURFACES SCHEDULED FOR REMODELING, RELOCATION, OR DEMOLITION UNLESS SHOWN AS RETAINED OR RELOCATED ON
- F. MAINTAIN ELECTRICAL CONTINUITY OF EXISTING SYSTEMS. REMOVE OR RELOCATE ELECTRICAL BOXES, CONDUIT, WIRING, EQUIPMENT, LUMINAIRES, AND THE LIKE, AS REQUIRED IN REMOVED OR REMODELED AREAS IN THE EXISTING CONSTRUCTION AFFECTED BY THIS WORK.
- G. REMOVE AND RESTORE WIRING WHICH SERVES USABLE EXISTING OUTLETS CLEAR OF THE CONSTRUCTION OR DEMOLITION.
- H. IF EXISTING JUNCTION BOXES WILL BE MADE INACCESSIBLE, OR IF ABANDONED OUTLETS SERVE AS FEED THROUGH BOXES FOR OTHER EXISTING ELECTRICAL EQUIPMENT WHICH IS BEING RETAINED, PROVIDE NEW CONDUIT AND WIRE TO BYPASS THE ABANDONED OUTLETS.
- IF EXISTING CONDUITS PASS THROUGH PARTITIONS OR CEILING WHICH ARE BEING REMOVED OR REMODELED, PROVIDE NEW CONDUIT AND WIRE TO REROUTE CLEAR OF THE CONSTRUCTION OR DEMOLITION AND MAINTAIN SERVICE TO THE EXISTING LOAD.
- CONCEALED CONDUIT LOCATED IN CONCRETE WALLS OR HARDBOARD CEILING SPACES MAY BE ABANDONED IN PLACE, REMOVE CONDUCTORS AND TAG ABANDONED CONDUITS WITH CORRESPONDING SYSTEM AND TERMINATION POINT. CUT AND CAP ABANDONED CONDUIT. DO NOT EXTEND STUBS ABOVE FINISHED FLOOR.
- K. EXTEND CIRCUITING AND DEVICES IN EXISTING WALLS TO BE FURRED OUT.
- L. PROVIDE TEMPORARY SUPPORT FOR ELECTRICAL SYSTEMS THAT REMAIN IN PLACE.
- M. VERIFY EXACT LOCATION AND NUMBER OF EXISTING ELECTRICAL OUTLETS AND LUMINAIRES IN THE FIELD. LOCATIONS OF ITEMS SHOWN ON DRAWINGS AS EXISTING ARE PARTIALLY BASED ON RECORD AND OTHER DRAWINGS WHICH MAY CONTAIN ERRORS. VERIFY THE ACCURACY OF THE INFORMATION SHOWN PRIOR TO BIDDING AND PROVIDE SUCH LABOR AND MATERIAL AS IS NECESSARY TO ACCOMPLISH THE INTENT OF THE CONTRACT DOCUMENTS.
- N. REMOVE ABANDONED WIRING TO LEAVE SITE CLEAN.
- O. EXISTING LIGHTING WHICH IS TO REMAIN OR BE RELOCATED IS TO BE RELAMPED, REBALLASTED, AND CLEANED. LEAVE ALL LUMINAIRES IN PROPER WORKING ORDER. REPLACE DAMAGED OR BROKEN LENS AND/OR COMPONENTS.
- P. MAINTAIN ACCESS TO EXISTING ELECTRICAL INSTALLATIONS WHICH REMAIN ACTIVE. MODIFY INSTALLATION OR PROVIDE ACCESS PANEL AS APPROPRIATE.
- Q. WHERE DRAWINGS INDICATE EXISTING ELECTRICAL EQUIPMENT OR DEVICES TO BE RELOCATED AND/OR REUSED, REFURBISH THEM. THOROUGHLY CLEAN SUCH ITEMS. NOTIFY ARCHITECT OF ANY DEFECTS IN SUCH INSTALLATIONS. REPAIR ANY DAMAGE CAUSED BY DEMOLITION OR CONSTRUCTION PERFORMED UNDER THIS CONTRACT.
- R. PROVIDE UPDATED PANEL SCHEDULES AND DIRECTORIES THAT IDENTIFY EXISTING CIRCUITS AND NUMBER OF SPARE CIRCUITS AVAILABLE UPON COMPLETION OF DEMOLITION WORK.
- S. OFFER REMOVED LUMINAIRES, WIRING DEVICES, PANELBOARDS AND EQUIPMENT TO THE OWNER. IF OWNER CHOOSES TO RETAIN THESE ITEMS, RETURN SUCH ITEMS TO OWNER. CAREFULLY REMOVE AND DISPOSE OF ITEMS REJECTED BY OWNER FROM PROJECT SITE AND IN A LEGAL MANNER.
- T. RECONNECT EXISTING LUMINAIRES NOT SHOWN ON DRAWINGS AND AFFECTED DUE TO DEMOLITION TO NEAREST AVAILABLE EXISTING LIGHTING CIRCUIT ABLE TO TAKE THE ADDITIONAL LOAD.
- U. REFER TO SPECIFICATIONS FOR ADDITIONAL REQUIREMENTS.
- V. DRAWINGS AND SPECIFICATIONS COMPLIMENT EACH OTHER. REQUIREMENT BY EITHER INFERS REQUIREMENT BY BOTH.
- W. CONNECT EQUIPMENT AND DEVICES FURNISHED UNDER OTHER DIVISIONS OF THIS CONTRACT, BY OWNER OR BY OTHER CONTRACTS.
- X. UNLESS OTHERWISE NOTED, PROVIDE CONCEALED AND FLUSH MOUNTED INSTALLATION OF DEVICES AND EQUIPMENT IN AREAS.
- Y. PROVIDE SEPARATE EQUIPMENT GROUNDING CONDUCTOR IN 120 VOLT, MULTI-WIRE CIRCUITS.
- Z. FOR 120 VOLT, 20 AMP CIRCUITS, WHERE CIRCUIT DISTANCE FROM PANELBOARD TO FARTHEST DEVICE/FIXTURE EXCEEDS 75 FEET, PROVIDE #10 SIZE CONDUCTOR.
- AA. RUN ELECTRICAL CONDUIT CONCEALED AND PARALLEL TO BUILDING LINES. VERIFY WITH ARCHITECT.
- AB. RECEPTACLE OUTLETS SHALL COMPLY WITH CEC SECTION 210.7.
- AC. LIGHTS, SWITCHES AND CONTROL MECHANISMS SHALL COMPLY WITH CEC SECTION 404.
- AD. BRACE ELECTRICAL EQUIPMENT TO RESIST A HORIZONTAL FORCE THAT ACT IN ANY DIRECTION. COMPLY WITH TITLE 24 REQUIREMENTS.
- AE. INSTALL COMPLETE SYSTEM OF CONDUCTORS IN RACEWAY SYSTEM THROUGHOUT BUILDING FOR FEEDERS, BRANCH CIRCUITS, ETC.

SHEET INDEX

- E0.1 SYMBOL LIST AND GENERAL NOTES ELECTRICAL
- E2.1 FLOOR PLAN LIGHTING
- E2.2 LIGHTING CONTROL FLOOR PLANS




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REVISIONS

SHEET TITLE THEATER HOUSE LIGHTING RETROFIT SYMBOL LIST AND GENERAL NOTES - ELECTRICAL

SCALE: NO SCALE DATE: Sept. 9, 2014

FILE: 0380E01_CAN.DWG - E0.1 | EDIT: 9/9/2014 6:08 PM BY HAIP | PLOT: 9/9/2014 6:17 PM BY HAI PHAN

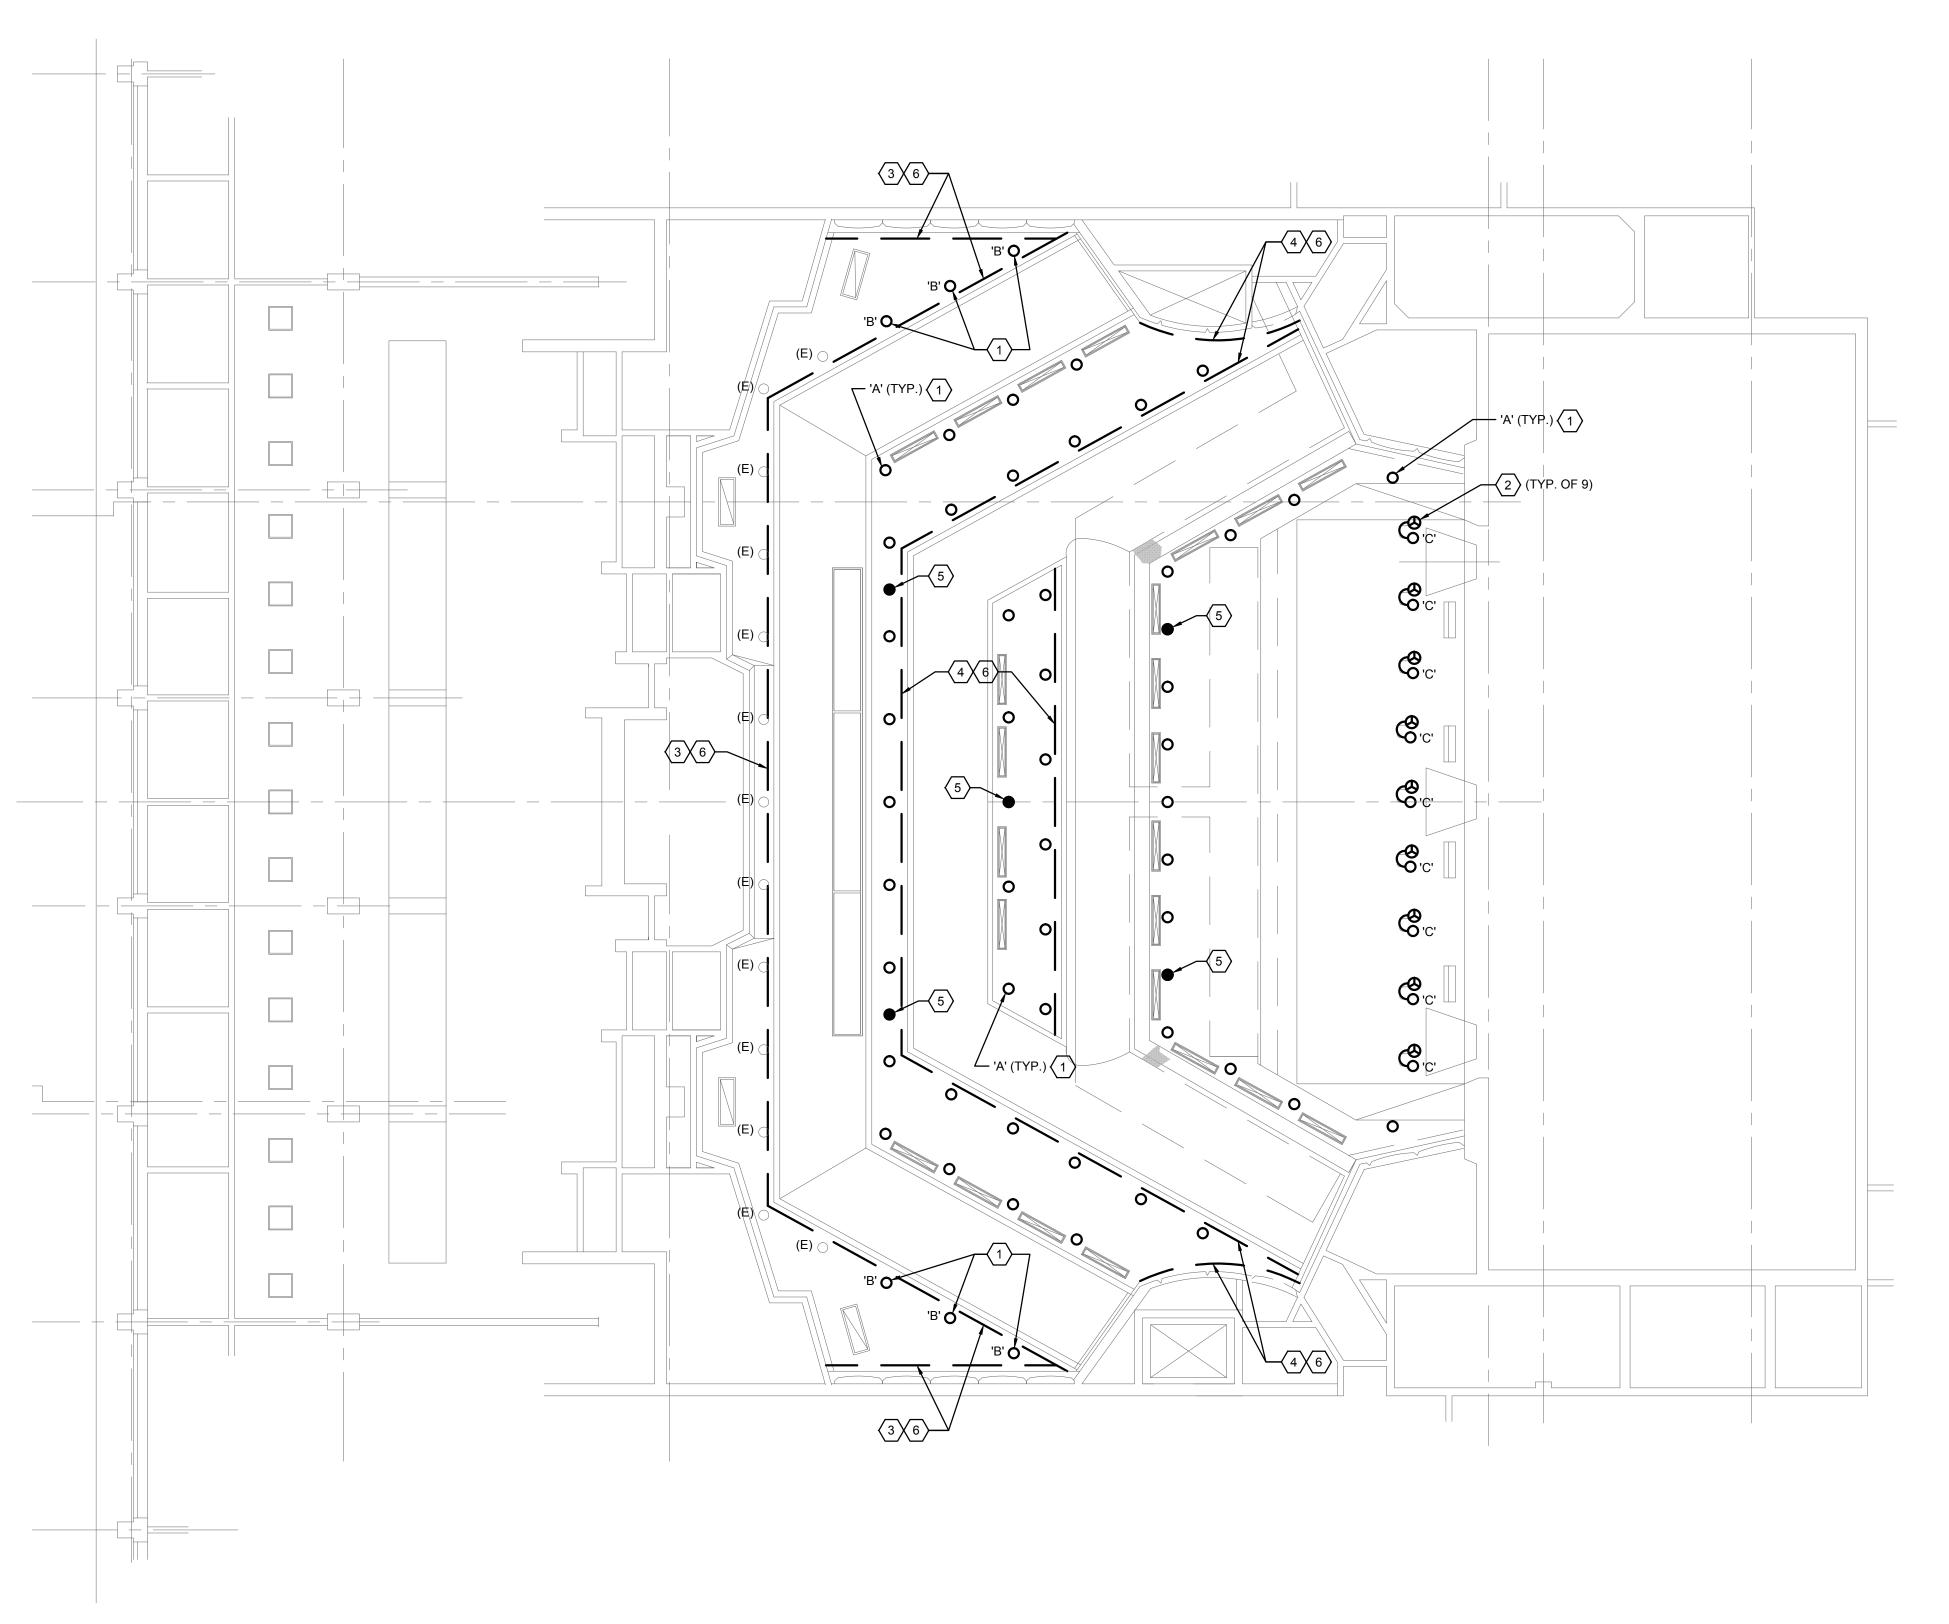

- A. COORDINATE EXACT LOCATION AND MOUNTING HEIGHT OF LUMINAIRES AND LIGHTING CONTROLS WITH THEATRICAL LIGHTING CONSULTANT PRIOR TO INSTALLATION.
- B. REFER TO THEATRICAL LIGHTING CONSULTANT DRAWINGS FOR ADDITIONAL INFORMATION AND LIGHTING CONTROL REQUIREMENTS.
- C. REFER TO THEATRICAL LIGHTING CONSULTANT DRAWINGS FOR LUMINAIRE SCHEDULE AND SYMBOLS.
- D. EXISTING LUMINAIRES AND LIGHTING CONTROLS NOT SHOWN ON PLAN SHALL REMAIN, U.O.N.

○ SHEET KEYNOTES

- 1 DISCONNECT AND REUSE EXISTING LIGHTING CIRCUIT AS PART OF LED LUMINAIRE REPLACEMENT. LUMINAIRES TO BE RECONNECTED BACK TO EXISTING DIMMER
- DISCONNECT AND REMOVE EXISTING LUMINAIRES AND PROVIDE NEMA L5-20R RECEPTACLE FOR CONNECTION TO NEW REPLACEMENT TYPE 'C' LUMINAIRES. REUSE EXISTING JUNCTION BOX AND CIRCUIT FOR NEW RECEPTACLE.
- 3 RELAMP/REPAIR EXISTING FLUORESCENT LUMINAIRES TO REMAIN.
- 4 REMOVE EXISTING LAMPS AND ABANDON FLUORESCENT LUMINAIRES IN PLACE.
- REPLACE EXISTING INCANDESCENT LAMP WITH LED RETROFIT LAMP IN EXISTING DOWNLIGHT.
- 6 <u>ADD ALTERNATE</u>: DISCONNECT AND REMOVE EXISTING FLUORESCENT LUMINAIRES WITH NEW TYPE 'D' LUMINAIRES. RECONNECT COMPLETE TO EXISTING LIGHTING CIRCUIT AS REQUIRED TO PLACE BACK INTO SERVICE.




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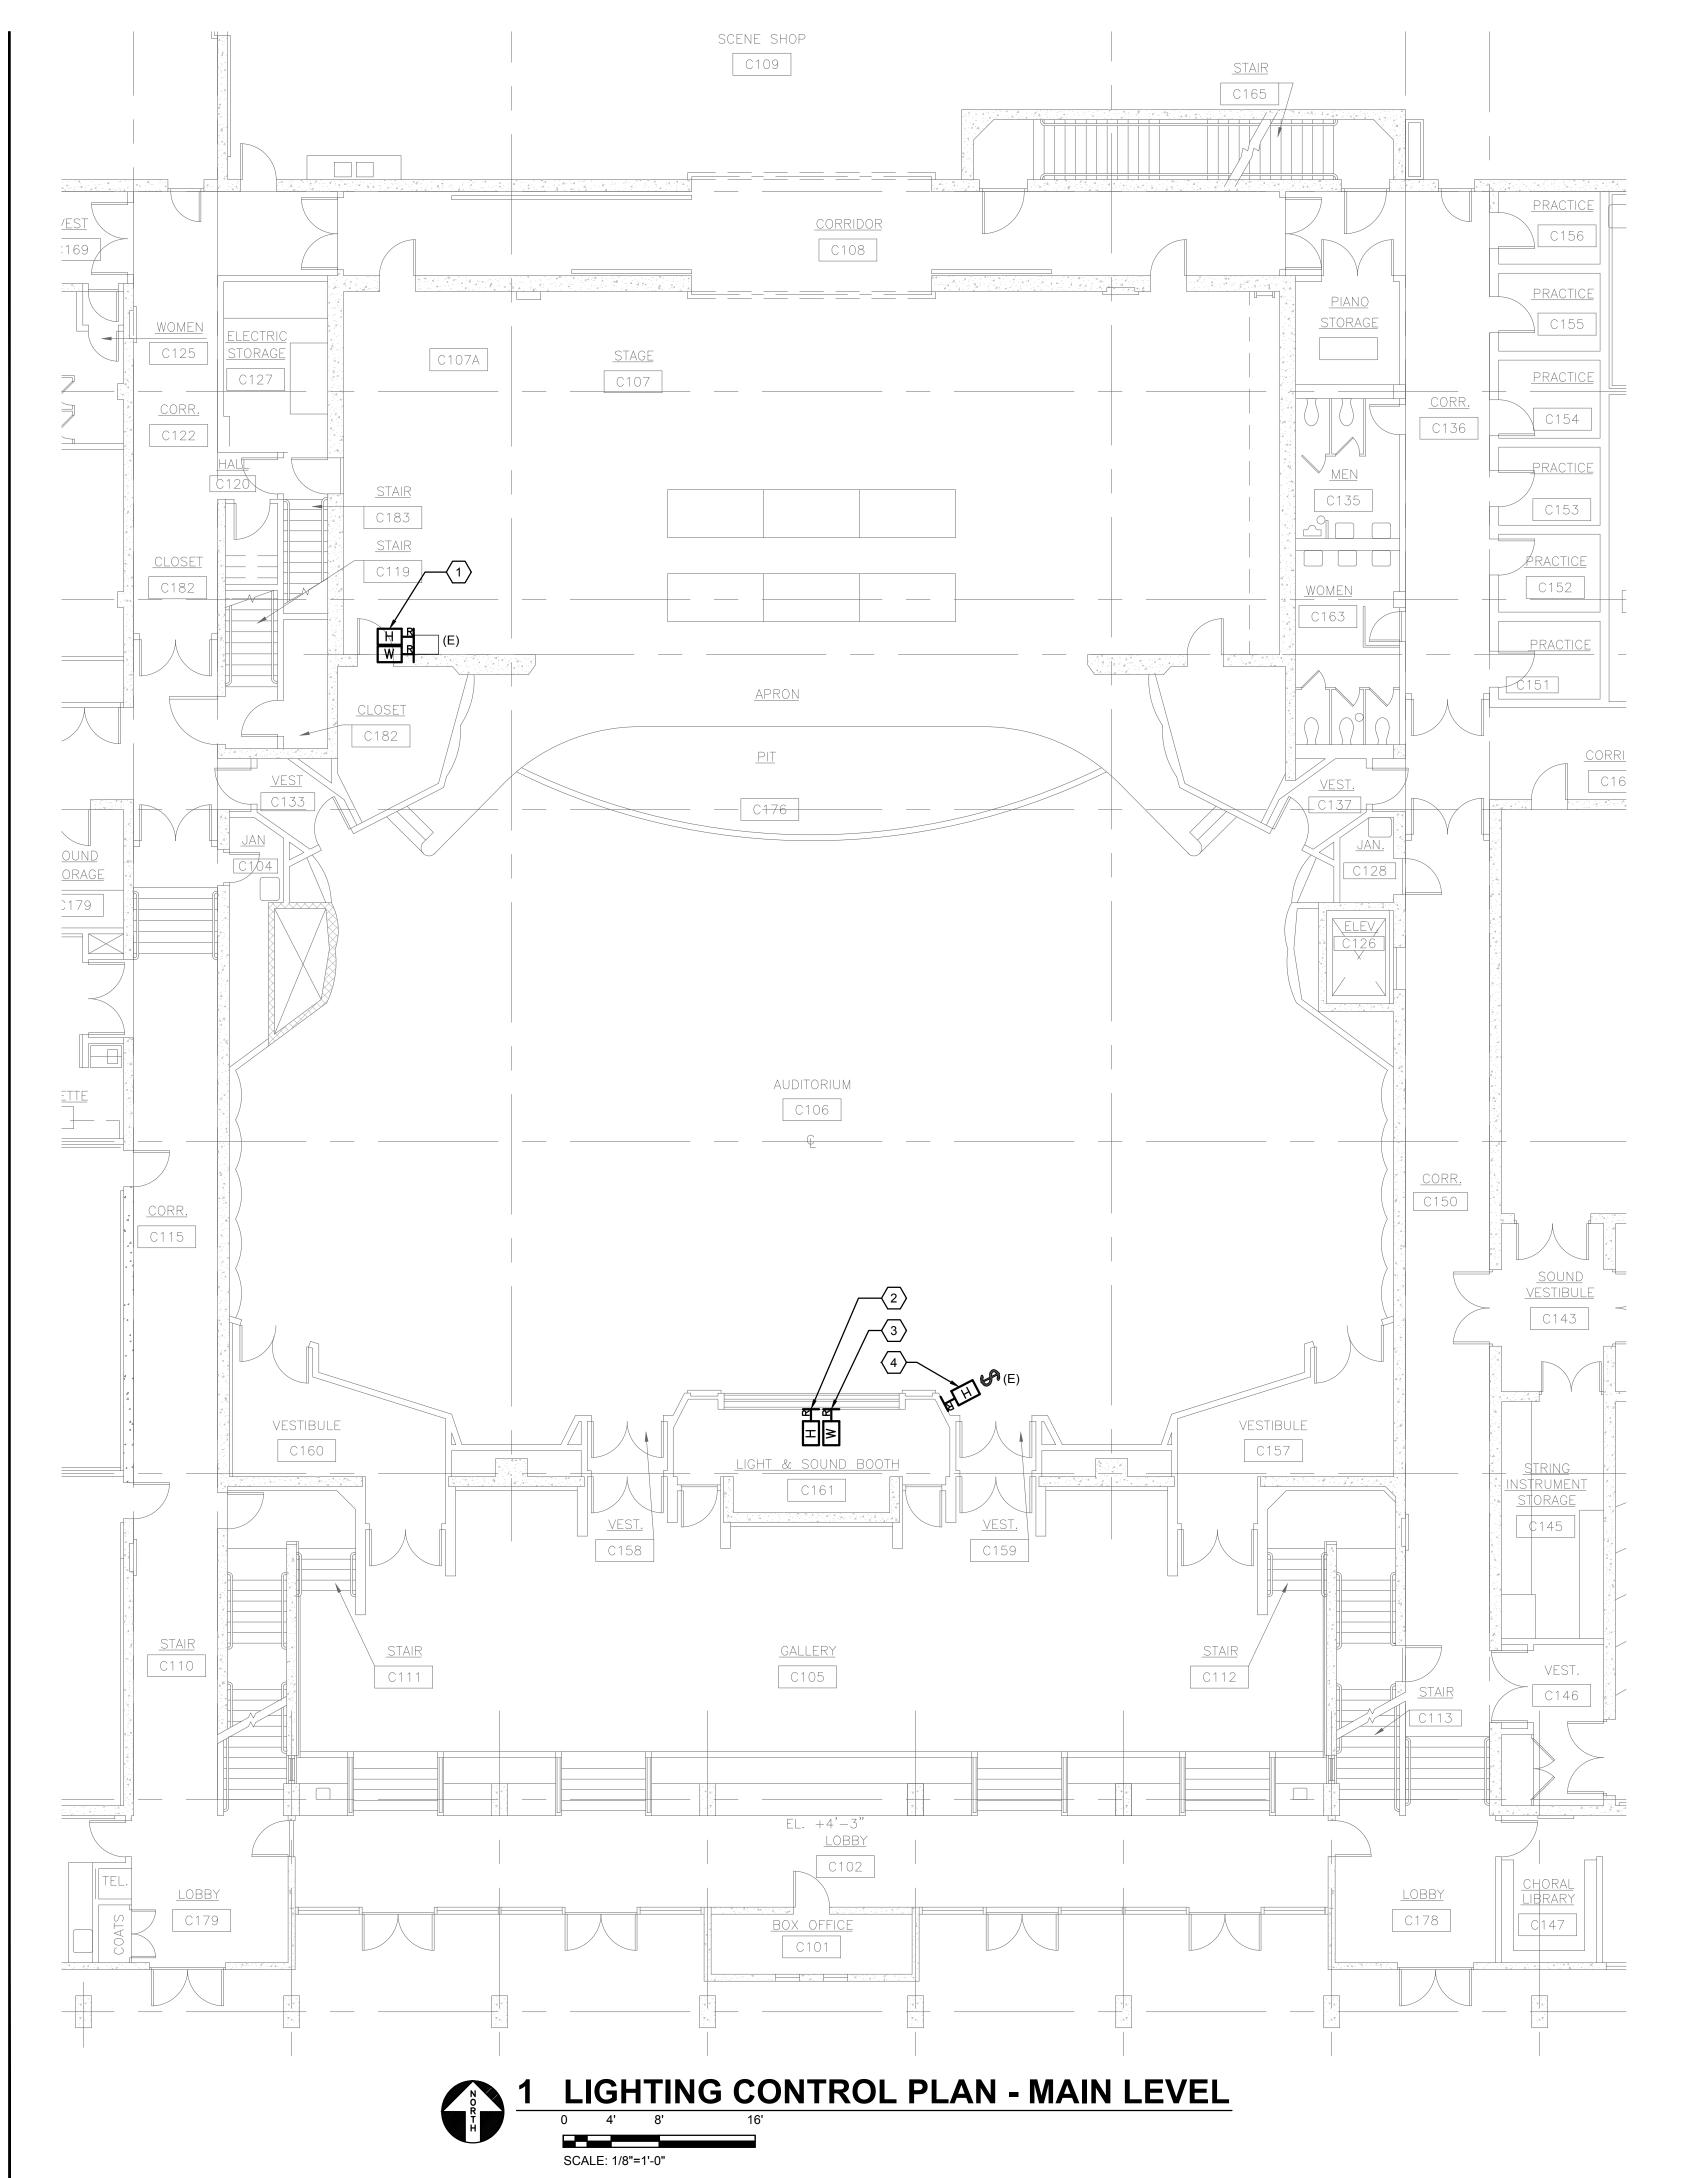
SHEET TITLE
THEATER HOUSE
LIGHTING RETROFIT
FLOOR PLAN LIGHTING

SCALE: 1/8" = 1'-0" DATE: Sept. 9, 2014

E2.1

Date Signed: 9/9/14




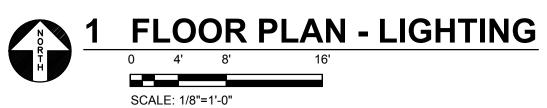

- A. COORDINATE EXACT LOCATION AND MOUNTING HEIGHT OF LIGHTING CONTROLS WITH THEATRICAL LIGHTING CONSULTANT PRIOR TO INSTALLATION.
- B. REFER TO THEATRICAL LIGHTING CONSULTANT DRAWINGS FOR ADDITIONAL INFORMATION AND LIGHTING CONTROL REQUIREMENTS.

○ SHEET KEYNOTES

- DISCONNECT AND REMOVE EXISTING RACK-MOUNTED HOUSE LIGHT CONTROL STATION AND WORKLIGHT CONTROL STATION AND REPLACE WITH NEW STAGE MANAGER'S PANEL WORKLIGHT/HOUSE LIGHT CONTROL PANEL. RECONNECT COMPLETE BACK TO EXISTING CIRCUIT TO PLACE BACK INTO SERVICE.
- DISCONNECT AND REMOVE EXISTING HOUSE LIGHT SLIDER CONTROL STATION AND REPLACE WITH NEW HOUSE LIGHT MASTER STATION 'HLM'. PROVIDE NEW SURFACE BACK BOX AS REQUIRED. RECONNECT COMPLETE BACK TO EXISTING CIRCUIT TO PLACE BACK INTO SERVICE.
- 3 DISCONNECT AND REMOVE EXISTING WORK LIGHT CONTROL STATION AND REPLACE WITH NEW WORKLIGHT CONTROL STATION 'WL'. REUSE EXISTING BACK BOX. RECONNECT COMPLETE BACK TO EXISTING CIRCUIT TO PLACE BACK INTO SERVICE.
- 4 DISCONNECT AND REMOVE EXISTING HOUSE LIGHT CONTROL STATION AND REPLACE WITH NEW HOUSE LIGHT CONTROL STATION 'HL'. REUSE EXISTING BACK BOX AND LOCKING COVER. RECONNECT COMPLETE BACK TO EXISTING CIRCUIT TO PLACE BACK INTO SERVICE.
- DISCONNECT AND REMOVE EXISTING ETC UNISON ER-4 EXTERNAL PROCESSING RACK AND REPLACE WITH NEW ETC UNISON ERn2 EXTERNAL PROCESSING RACK WITH 4-PORT NETWORK SWITCH. RECONNECT COMPLETE BACK TO EXISTING CIRCUIT TO PLACE BACK INTO SERVICE.

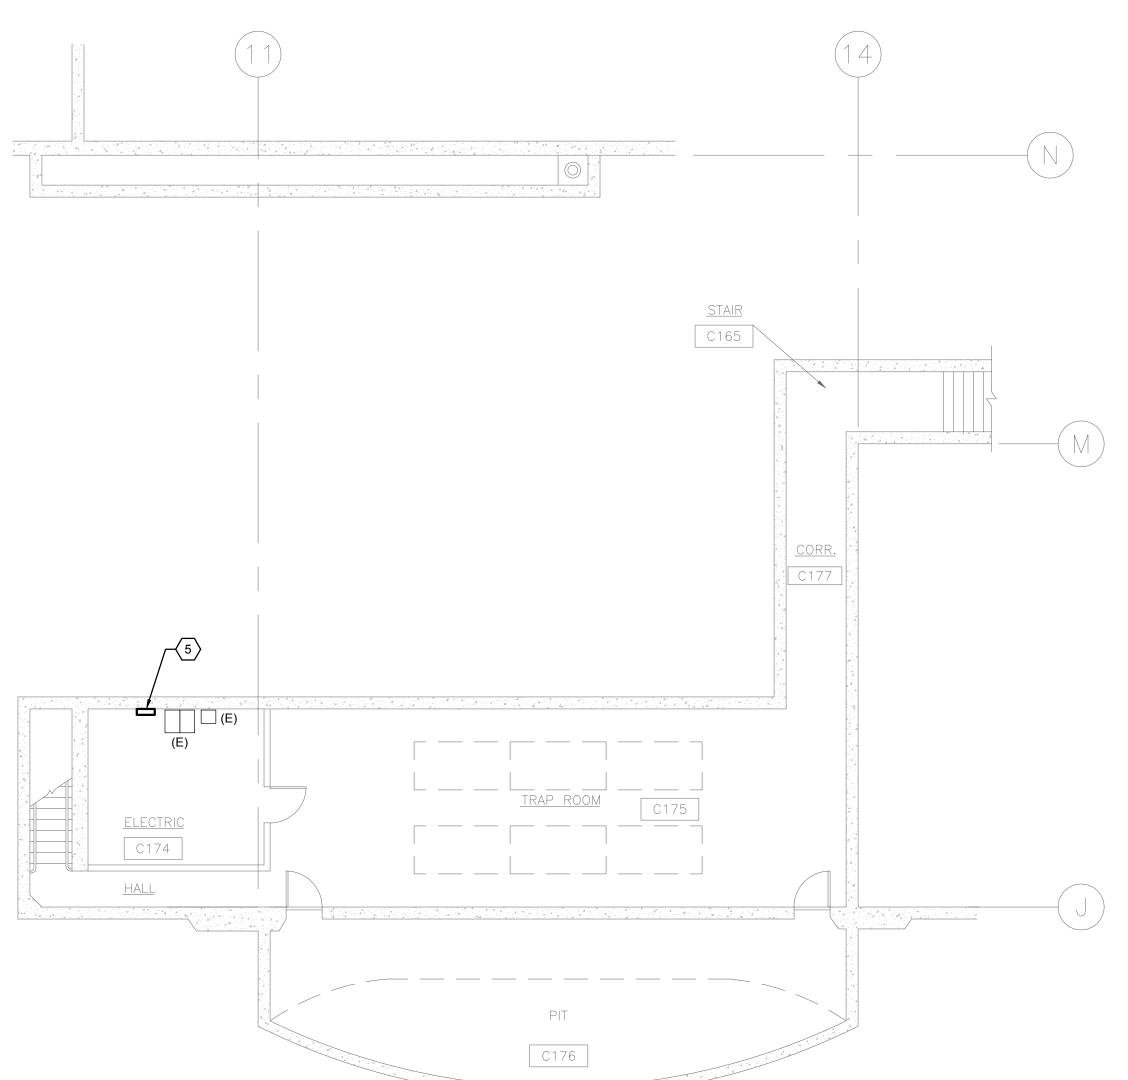





PROJECT 2014-0380

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RETROFIT JILDING 3

NA/COLLEGE OF SAN MAT IR HOUSE LIGHTING RETRO NDA COLLEGE - BUILDING

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REVISIONS

SHEET TITLE
THEATER HOUSE
LIGHTING RETROFIT
LIGHTING CONTROL
FLOOR PLAN


SCALE: 1/8" = 1'-0" DATE: Sept. 9, 2014

E2.2

- 1 PROVIDE DMX JUMPERS TO DAISY CHAIN DMX SIGNAL FROM FIXTURE TO FIXTURE FOR FIXTURES TYPE A, B & D. SEE ALTERNATES.
- 2 DISCONNECT AND REMOVE EXISTING INCANDESCENT DOWNLIGHT FIXTURES AND DISPOSE OF AS DIRECTED BY OWNER. EXISTING APERTURES TO BE REUSED FOR INSTALLATION OF NEW TYPE A & B FIXTURES WITH ADAPTER RINGS. RECONNECT EXISTING WIRE HOME-RUNS (TO EXISTING SENSOR SR24 DIMMER RACK, CIRCUITS 218-232,) TO POWER SUPPLIES OF NEW TYPE A & B FIXTURES.
- 3 REMOVE EXISTING CENTURY LEKOLITE LUMINAIRES AND TURN OVER TO OWNER MOUNT NEW TYPE 'C' FIXTURES TO EXISTING MOUNTING BRACKETS AND PLUG INTO NEW NEMA L5-20 (TWISTLOCK) RECEPTACLE.
- 4 INSTALL NEW 2-GANG FACEPLATE ON EXISTING 2-GANG JUNCTION BOX WITH NEW NEMA L5-20 (TWISTLOCK) RECEPTACLE. TYPICAL OF 9. VERIFY DIMENSIONS OF EXISTING BACK BOXES IN THE FIELD PRIOR TO MANUFACTURER OF NEW FACEPLATES.
- 5 BASE BUILDING CONTRACT: RELAMP/REPAIR ALL EXISTING FLUORESCENT COVE FIXTURES ISO THAT ALL ARE FULLY OPERABLE.
- 6 NOT USED
- 7 ADD ALTERNATE #1: REMOVE ALL EXISTING FLUORESCENT COVE FIXTURES AND REPLACE WITH FIXTURE TYPE D.
- 8 AT EXISTING NORMALLY OFF EMERGENCY LIGHTING FIXTURES: REPLACE INCANDESCENT LAMP WITH LED RETROFIT LAMP (TYPICAL OF 5 EMERGENCY FIXTURES.)

DESCRIPTION
Fixture type (see schedule for details)
Down light luminaire, ceiling mounted in existing opening
Indicates fixture on an emergency circuit
Fluorescent fixture
Speciality outlet — Single NEMA L5—20 receptacle. Mount on existing 4x4 back box
Junction box 4-11/16" sq. x 2-1/8" D. U.N.O.
Toggle switch — SPST
Existing Worklight Control Station
Existing House Light Control Station

	SCHEDULE OF LIGHTING FIXTURES						
	REFER TO ARCHITECTURAL DETAILS TO DETERMINE NECESSARY FIXTURE MOUNTING ACCESSORIES AND TO APPLICABLE BUILDING CODES FOR REQUIRED FIXTURE SUPPORTS, AND FOR MAINTAINING CEILING FIRE RATINGS.						
TYPE	FIXTURE DESCRIPTION	MFR'S CATALOG NO.	MOUNTING	VOLTAGE	LAMPS/WATTAGE		
A	RECESSED LED DOWNLIGHT, 2700 KELVIN, 2500 LUMENS, 45 DEGREE BEAM ANGLE, DMX-RDM CONTROLLED, WITH CEILING OPENING ADAPTER RING	GOTHAM ICO 27/25 6AR 45 120 DMXR, NPP16D, GRA-610JZ (VERIFY OPENING DIMENSIONS)	RECESSED HT. AS NOTED	120	2700K WHITE LED 35 WATTS		
B	RECESSED LED DOWNLIGHT, 2700 KELVIN, 2000 LUMENS, 70 DEGREE BEAM ANGLE, DMX—RDM CONTROLLED, WITH CEILING OPENING ADAPTER RING	GOTHAM ICO 27/20 6AR 70 120 DMXR, NPP16D, GRA-610JZ (VERIFY OPENING DIMENSIONS)	RECESSED HT. AS NOTED	120	2700K WHITE LED 35 WATTS		
C	THEATRICAL ELLIPSOIDAL REFLECTOR SPOTLIGHT WITH ROTATING LENS BARREL, 36 DEGREE BEAM SPREAD, AND NEMA L5-20 MALE CONNECTOR (NOTE: NO C-CLAMP REQUIRED)	ELECTRONIC THEATER CONTROLS 436	BOLT AT PIVOT POINT TO EXISTING BRACKET	120	HPL 750/115X 1500 HOUR AVG. RATED LIFE, 3050K		
SEE ALTERNATES	DMX CONTROLLED COLOR CHANGING LINEAR LED FIXTURE W/DIE—CAST ALUMINUM HOUSING, POLYCARONATE LENS, RED/GREEN/BLUE LED CHANNELS, 968 LUMEN OUTPUT, 50 DEGREE X 70 DEGREE BEAM SPREAD. PROVIDE FIXTURE QUANTITIES PER PLANS — VERIFY LENGTH IN FIELD. PROVIDE ACCESSORIES FOR A COMPLETE AND FULL FUNCTION LIGHTING SYSTEM INCLUDING POWER SUPPLY/CONTROLS (DATA—ENABLERS), LEAD JUMPERS (FIELD VERIFY LENGTH) AND JUMPER CABLES (FIELD VERIFY LENGTH)	COLOR KINETICS iCOLOR COVE MX POWERCORE #123-000004-08 #106-000004-00 #108-000045-00 #108-00049-01	SURFACE	120	LED R/G/B		

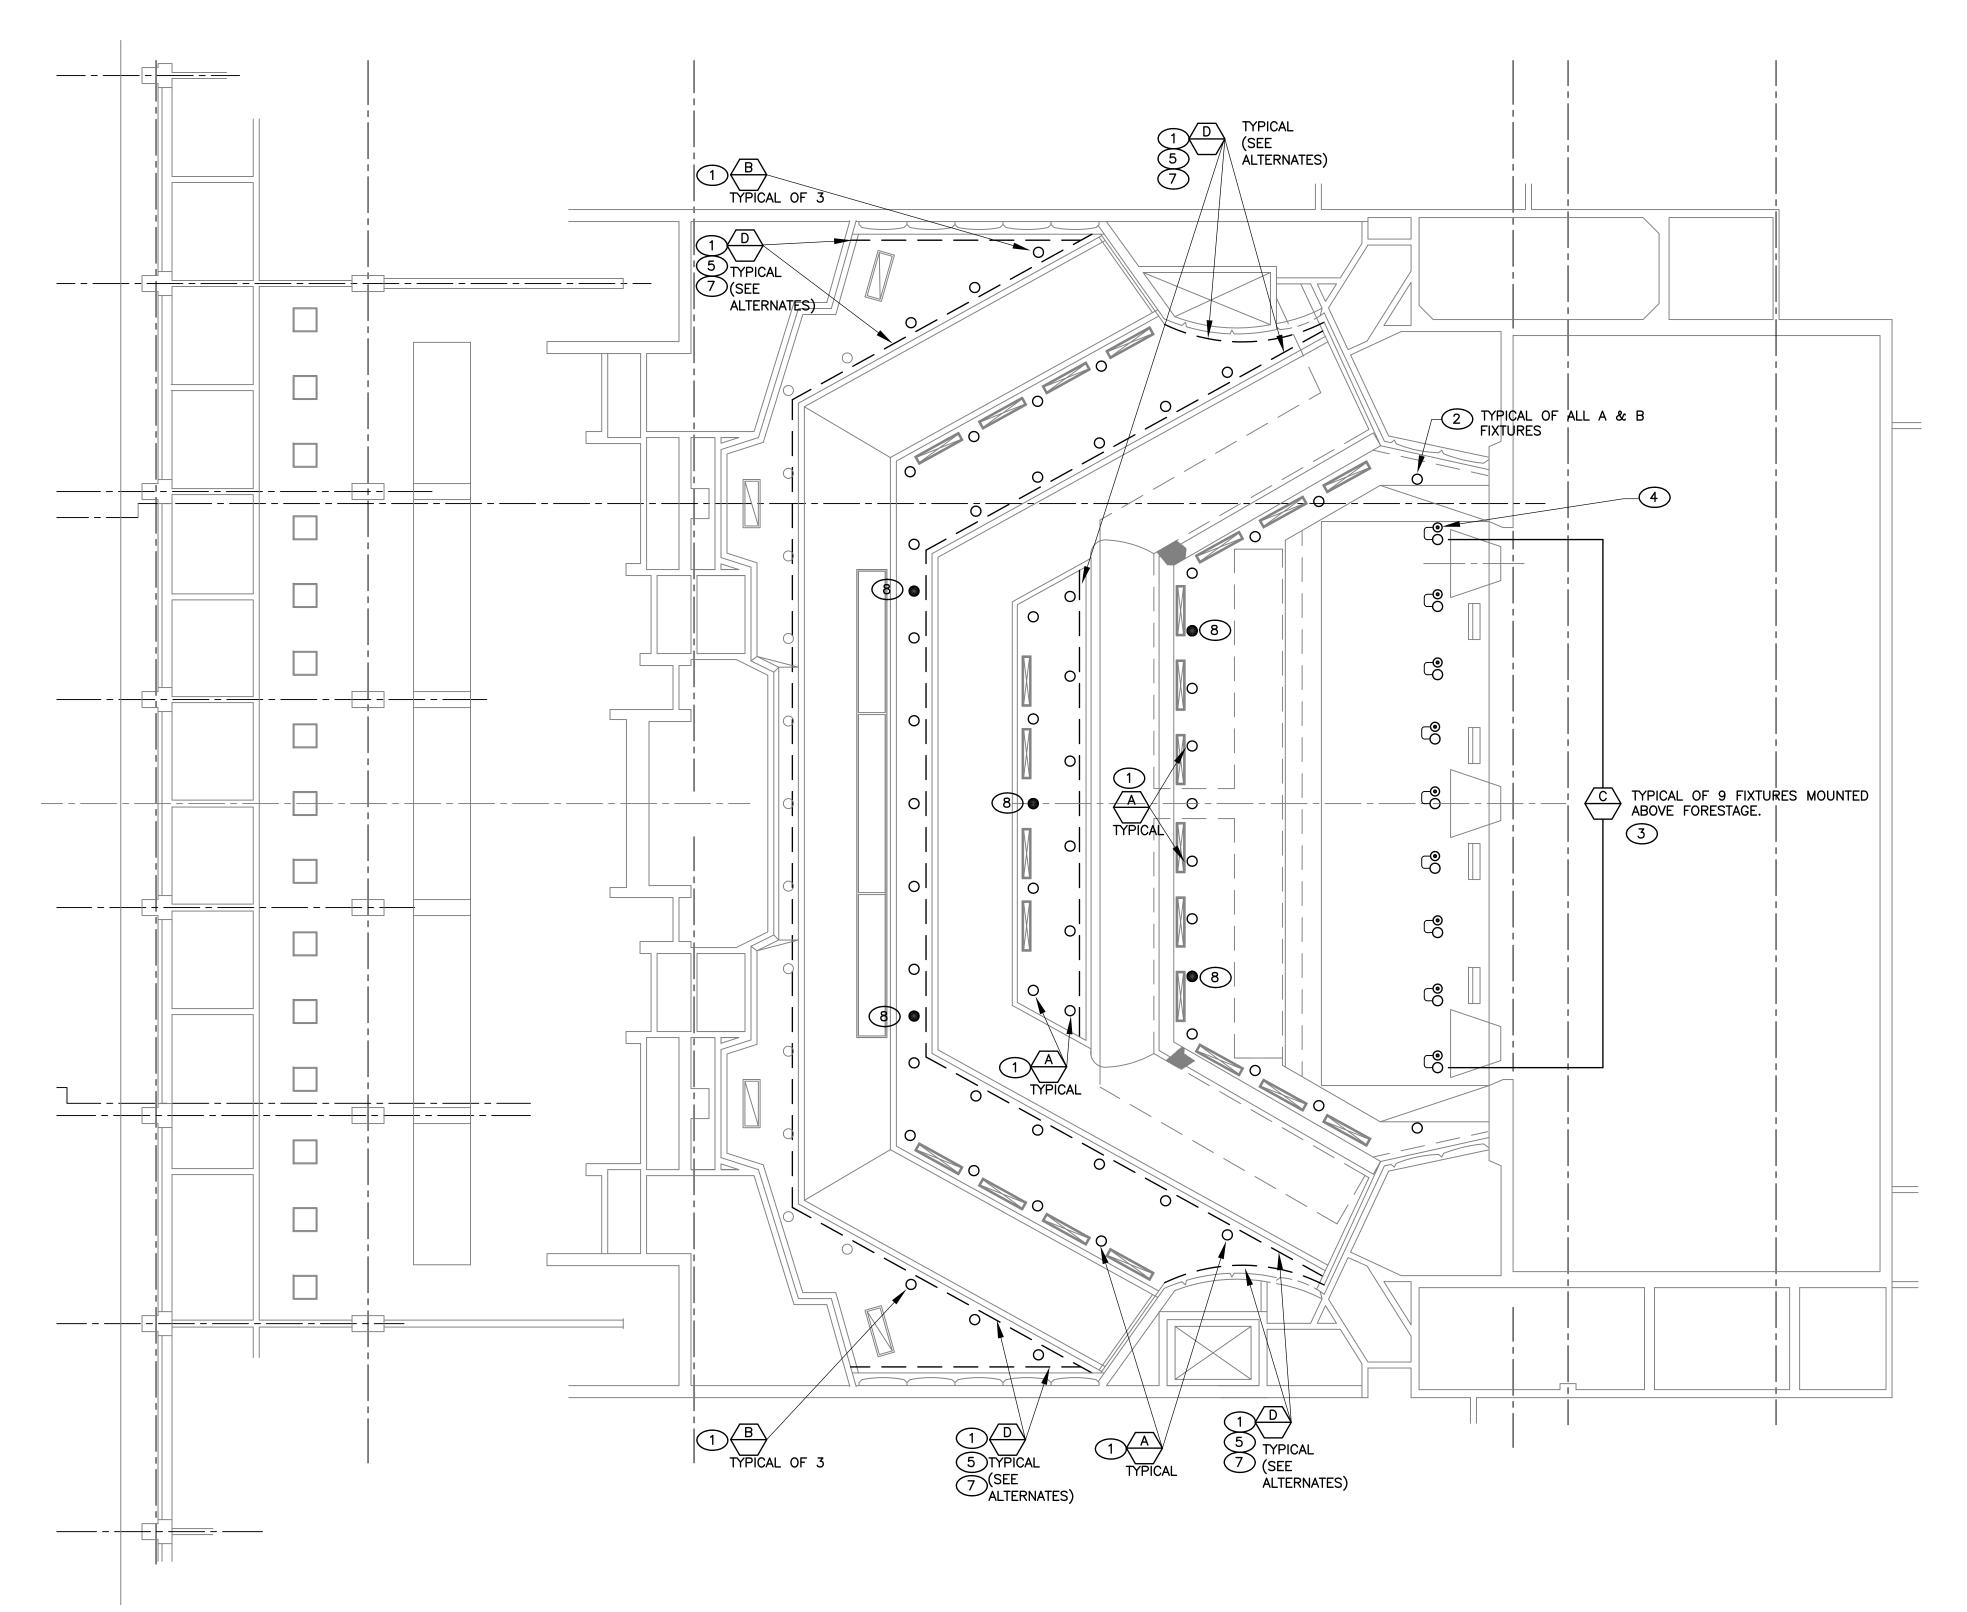

REFLECTED CEILING PLAN

LEGI

COL


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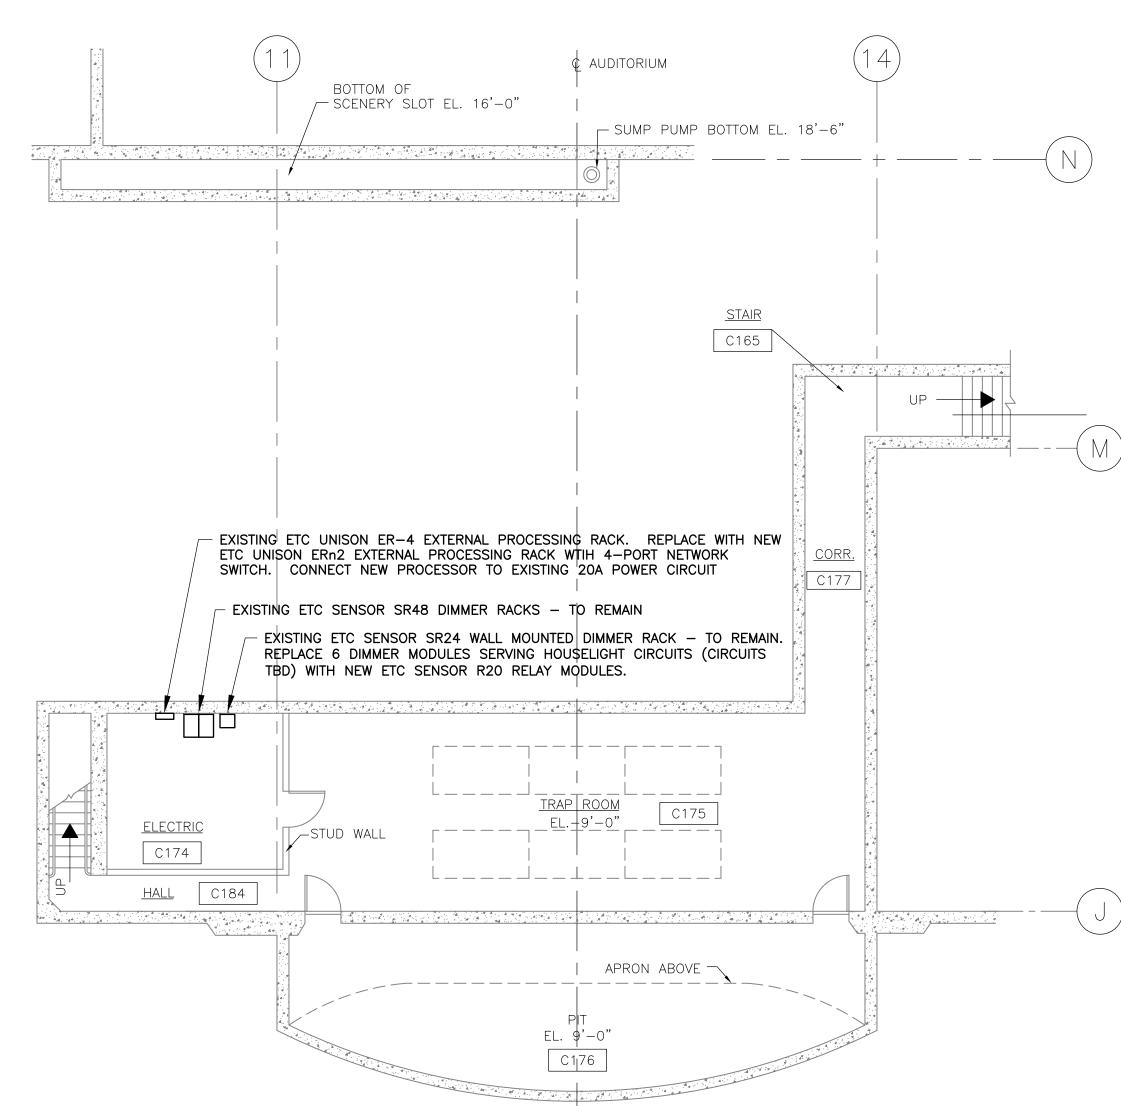
REVISIONS

SHEET TITLE
THEATER HOUSE
LIGHTING RETROFIT
REFLECTED CEILING
PLAN

SCALE: AS NOTED DATE: September 16, 2014

TL2.1



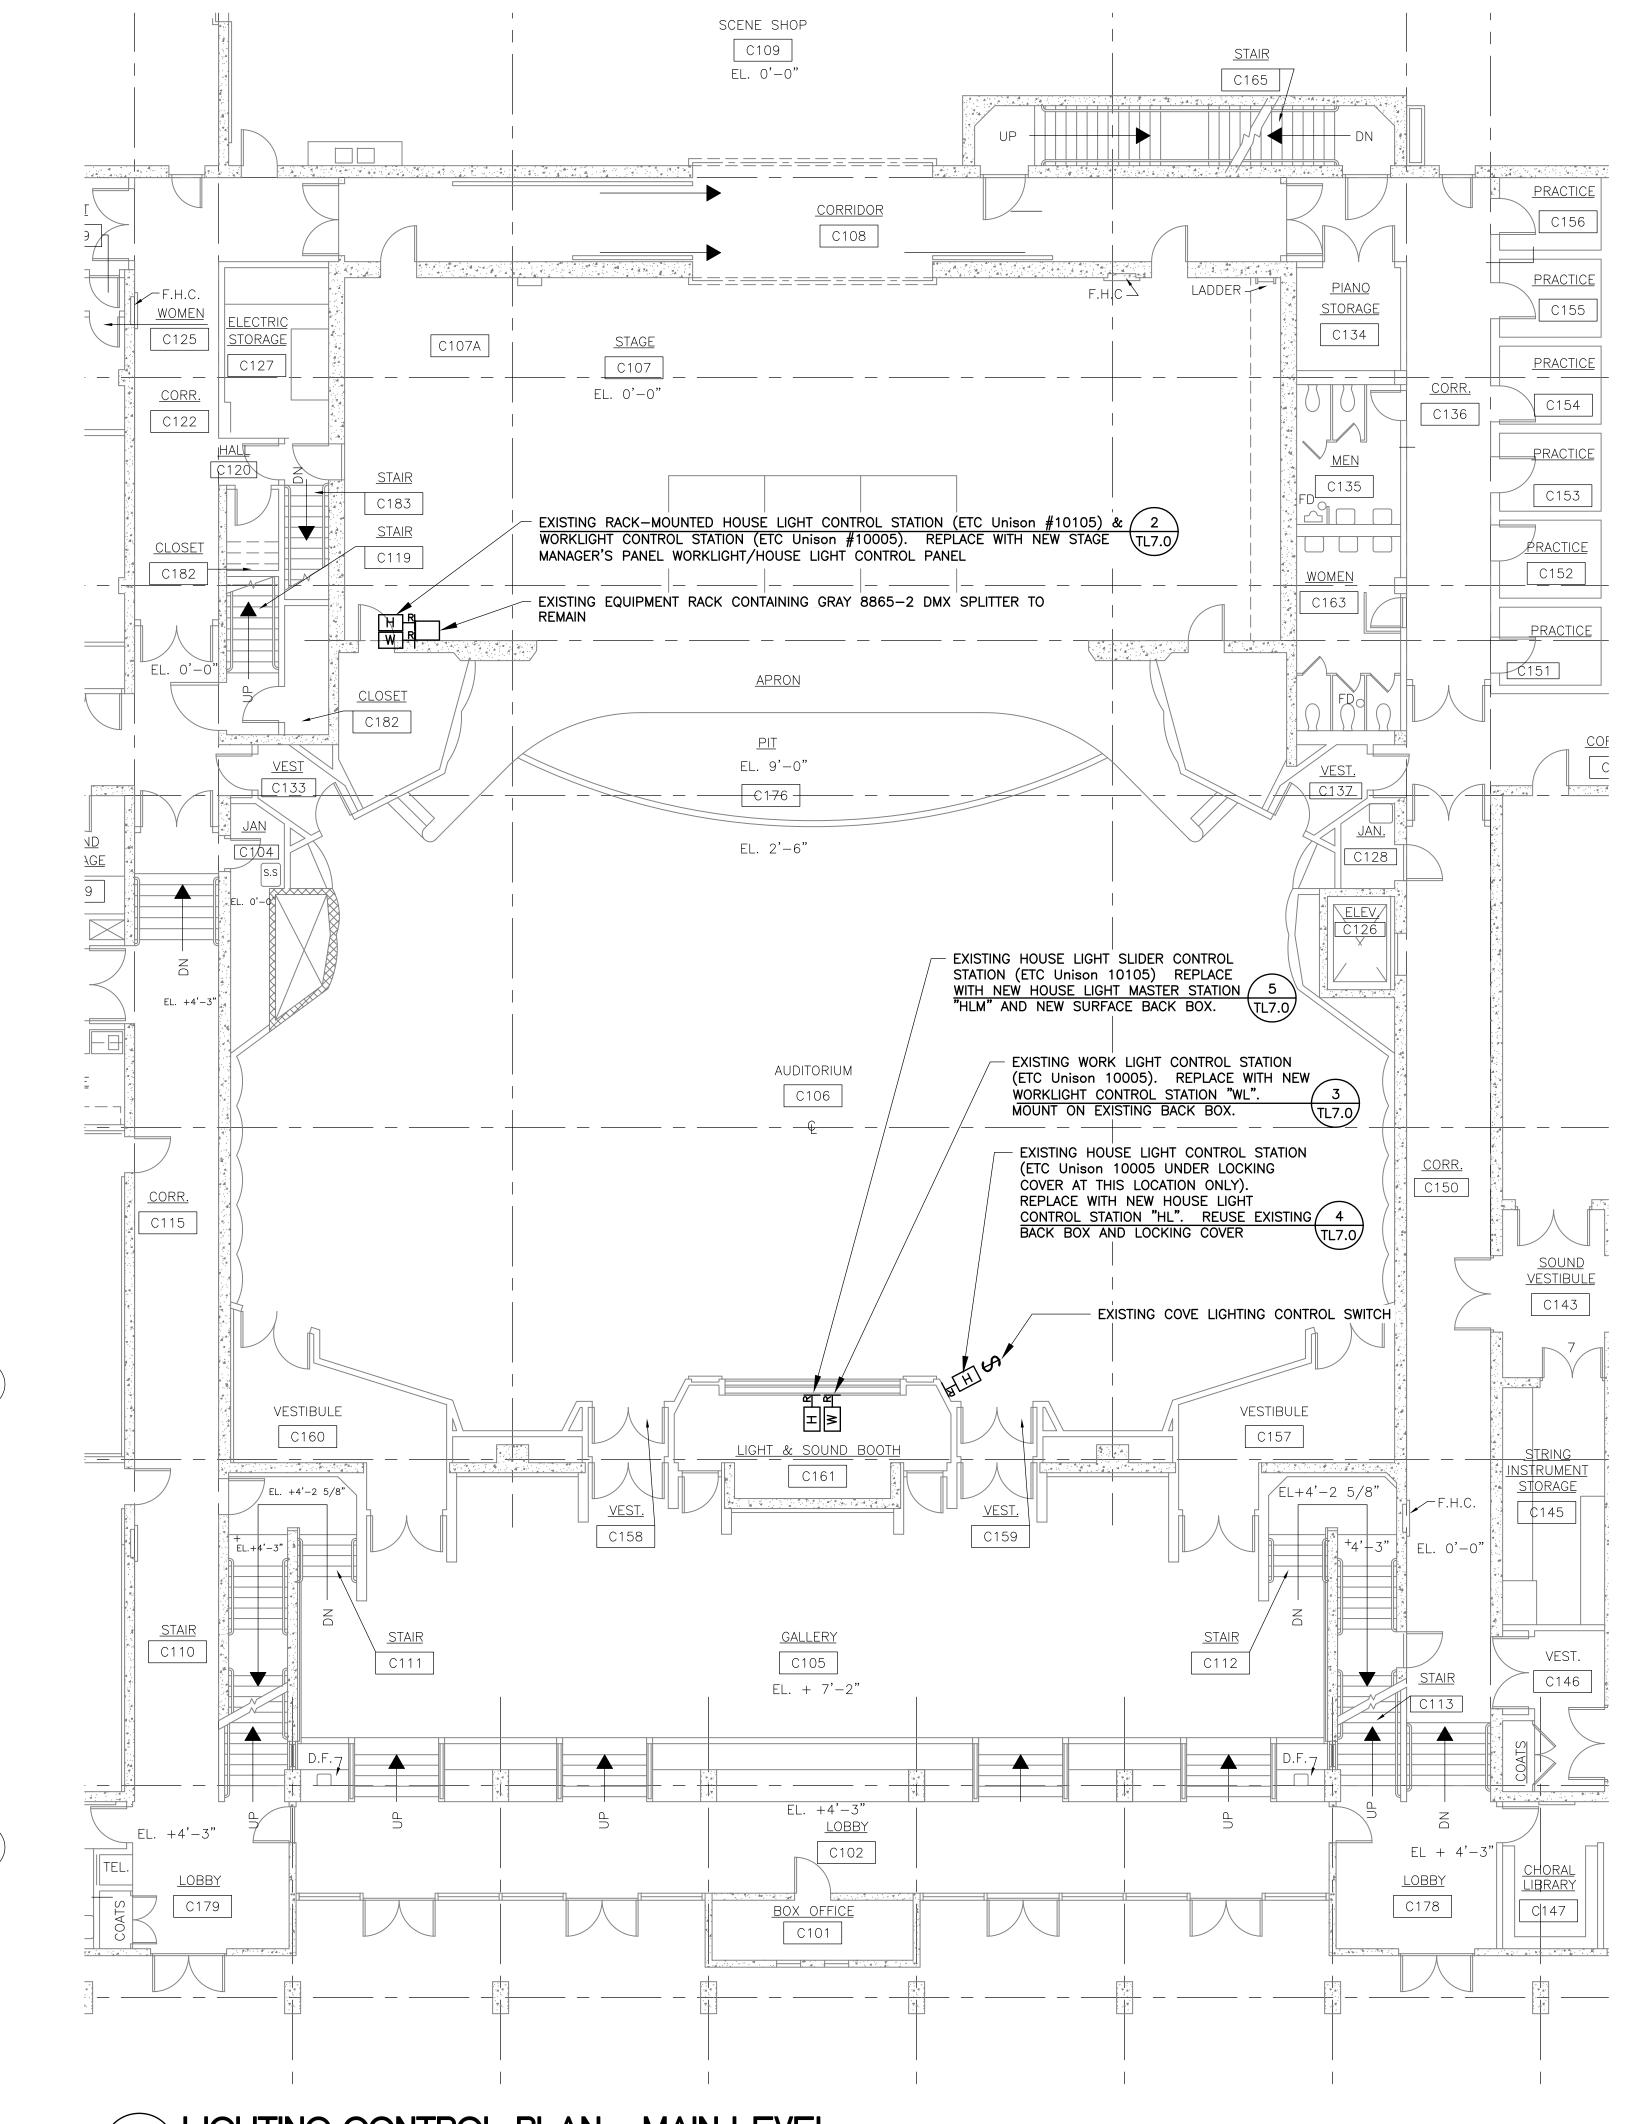

1 LIGHTING CONTROL PLAN - MAIN LEVEL

1 LIGHTING CONTROL PLAN - MAIN LEVEL

N

TL2.2

SCALE: AS NOTED

DATE: September 16, 2014

SHEET TITLE
THEATER HOUSE

MAIN FLOOR PLAN

LIGHTING RETROFIT

TEGE

COL

COMMUNITY

MATEO (CAÑAI THEATE

REVISIONS

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SCALE: 1/4" = 1'-0"DATE: September 16, 2014

TL7.0


_8 1/2" **ENGRAVING** -HOUSE LIGHTS 1/8" H. **ENGRAVING** 4 1/2"

HLM PROGRAM			
BUTTON	PROGRAM		
HOUSE LIGHTS			
PRESET 1	USER		
PRESET 2	USER		
PRESET 3	USER		
PRESET 4	USER		
OFF	BLACKOUT		
SLIDERS	CIRCUITS		
DOWNLIGHTS ONSTAGE	TBD		
DOWNLIGHTS HOUSE	TBD		
DOWNLIGHTS REAR	TBD		
COVE RED*	TBD		
COVE GREEN*	TBD		
COVE BLUE*	TBD		

*IF ALTERNATE NOT TAKEN, THESE SLIDERS STEEL OR ALUMINUM FACEPLATE W/BLACK SEMI-GLOSS FINISH AND WHITE DESIGNATIONS. FACE PLATE REMOVABLE FOR ACCESS.

CODE GAUGE, 4-GANG, 2.5" DEEP SURFACE BACK BOX.

HOUSELIGHT MASTER STATION "HLM"

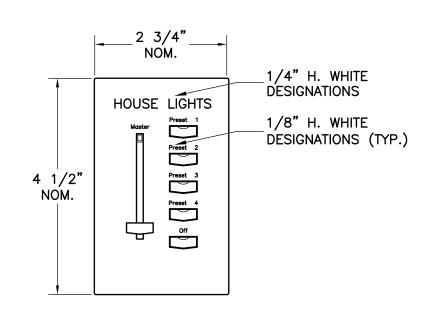


STEEL OR ALUMINUM FACEPLATE W/BLACK SEMI-GLOSS FINISH AND WHITE

DESIGNATIONS. FACE PLATE REMOVABLE FOR ACCESS.

IN REAR OF AUDIENCE MOUNT ON EXISTING SINGLE GANG BACK BOX WITH LOCKING COVER (REUSE EXISTING LOCKING COVER AND BACK BOX.) FIELD VERIFY BACK BOX DIMENSIONS

HOUSELIGHT STATION "HL"

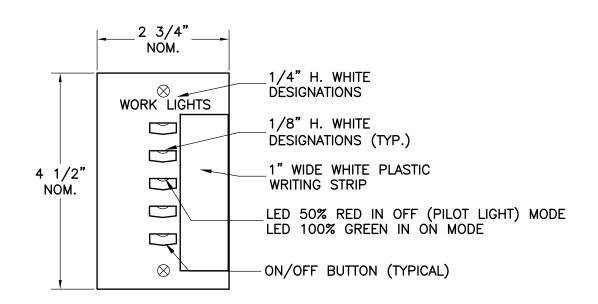

STEEL OR ALUMINUM FACEPLATE W/BLACK SEMI-GLOSS FINISH AND WHITE DESIGNATIONS. FACE PLATE REMOVABLE FOR ACCESS.


IN CONTROL ROOM MOUNT ON EXISTING SINGLE GANG BACK BOX. FIELD VERIFY BACK BOX DIMENSIONS.

WORKLIGHT STATION "WL"

SCHEDULE OF SIGNAL AND CONTROL CONDUCTORS

Cond. Group	Wire Count	Cable type (or equal)	Conductor Use(s)
(D)	2PR#24	(1) Belden 9729	DMX (EXISTING - REUSE)
(H)	1PR#16 1#14	(1) Belden 8471 THHN	UNISON STATIONS (EXISTING — REUSE)
N X#	4PR#24	(1) Belden 1583A	NETWORK (NEW)


= Number of type in conduit

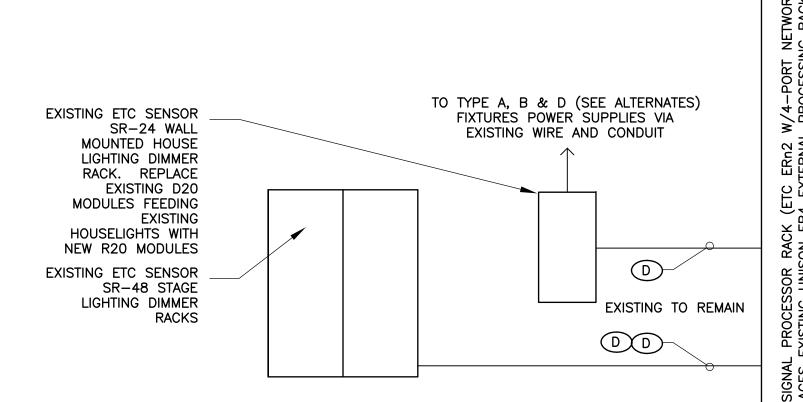


RECONNECT EXISTING 1-20A, 1 PHASE, 120VAC CIRCUIT TO NEW PROCESSOR RACK (SEE E-SHEETS) ELECTRICAL ROOM C174

THEATRE SYSTEM SIGNAL AND CONTROL RISER DIAGRAM

NOTES: 1. ALL NEW SIGNAL & CONTROL CONDUIT TO BE 3/4" U.N.O. 2. TYPES AND QUANTITIES OF SIGNAL & CONTROL CONDUCTORS ARE APPROXIMATE. ACTUAL TYPES & QUANTITES TO BE AS RECOMMENDED BY STAGE LIGHTING EQUIPMENT MANUFACTURER.

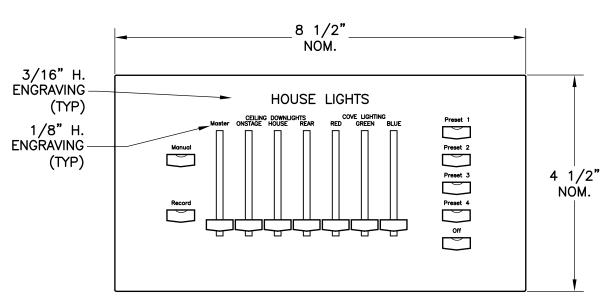

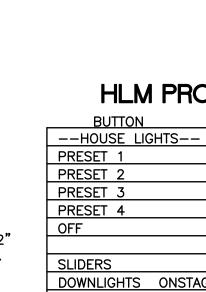

-HOUSE AND WORKLIGHT DESIGNATIONS CONTROLS AT THIS LOCATION HOUSE LIGHTS HOUSE & WORK LIGHT CONTROLS 1/8" H. WHITE DESIGNATIONS (TYP.) _1" WIDE WHITE PLASTIC_ WRITING STRIP STEEL OR ALUMINUM FACEPLATE W/BLACK SEMI-GLOSS FINISH AND WHITE


1/4" H. WHITE

KEYSWITCH TO LOCK OUT

DESIGNATIONS. FACE PLATE REMOVABLE FOR ACCESS.

3-UNIT STANDARD E.I.A. RACK MOUNTED PLATE TO REPLACE EXISTING. FIELD VERIFY DIMENSIONS.

HOUSE LIGHT/WORKLIGHT PANEL AT STAGE MANAGER'S PANEL

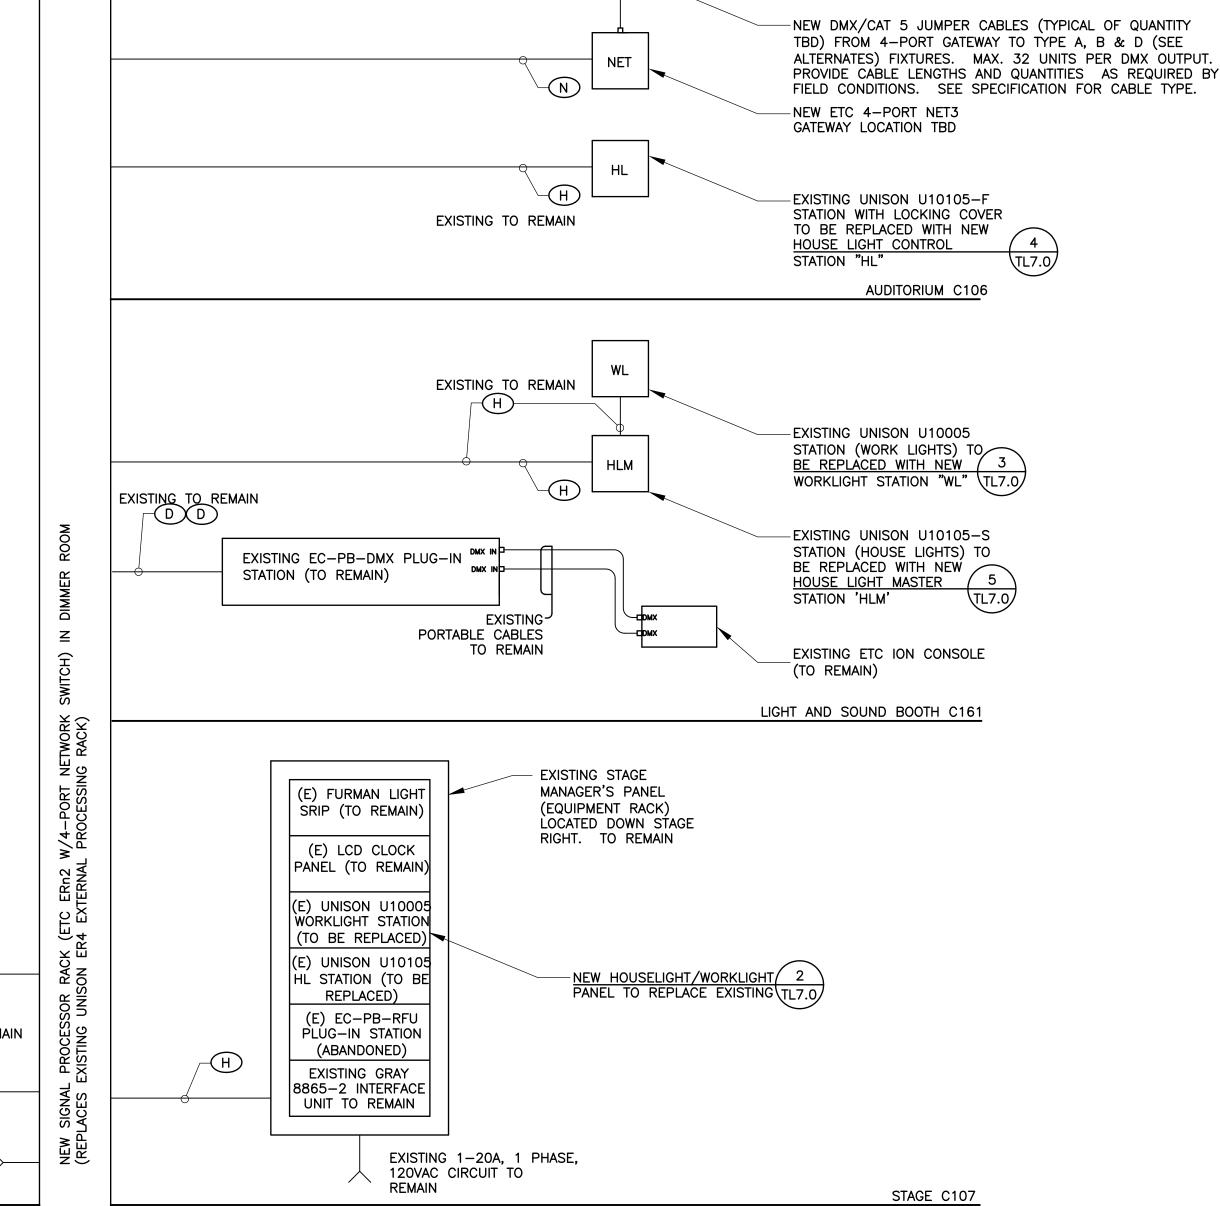

Abbreviations

<u>:</u>)	EXISTING
١	AMPERES, AMBER

AVAILABLE INTERRUPTING CAPACITY

AMERICAN WIRE GAUGE

CONDUIT, CLOSE, CONTROL

CIRCUIT BREAKER

CLG CEILING

COORD COORDINATE

CU COPPER

DIM DIMENSION

DRAWING

EACH

ELEVATION

FOOT, FEET GROUND G, GND

GROUND FAULT CIRCUIT INTERRUPTER

GROUND FAULT INTERRUPTER

HEIGHT

INCH, INCHES

KILOVOLT AMPERES

KILOWATT

LIGHT EMITTING DIODE

MINIMUM

MOUNT, MOUNTED

NOT APPLICABLE

NATIONAL ELECTRICAL MANUFACTURERS ASSOCIATION

NATIONAL ELECTRIC CODE

NOT TO SCALE

ROOM

REQUIRED

SWITCH

TYPICAL

UNDERWRITERS LABORATORIES

UNLESS OTHERWISE NOTED

VOLTS, VOLTAGE

WITHOUT

Connections / Equipment

JUNCTION BOX

WALL-MOUNTED JUNCTION BOX

General

DEMOLISH **EXISTING WORK NEW WORK**

DETAIL NUMBER AND SHEET LOCATION

KEYED NOTE

Miscellaneous

B-27,29,31

BRANCH CIRCUIT WIRING. ARROW INDICATES HOME RUN TO PANEL WITH CIRCUITS AS NOTED. WIRE SIZE IS #12 AWG MINIMUM UNLESS NOTED OTHERWISE. SHORT TICK MARKS INDICATE PHASE CONDUCTORS. LONG TICK MARKS INDICATE NEUTRAL CONDUCTORS. A SINGLE CURVED TICK MARK INDICATES INSULATED GREEN GROUND CONDUCTOR. SECOND CURVED TICK MARK INDICATES "ISOLATED GROUND" (GREEN INSULATION WITH YELLOW STRIPE) CONDUCTOR.

BRANCH PANEL

FLUSH WALL MOUNTED BRANCH PANEL

GROUNDING POINT

Raceways

CONDUIT CONCEALED IN WALL OR CEILING SPACE _ _ _ _ _ CONDUIT ROUTED BELOW FLOOR / GRADE CONDUIT/WIRING CONTINUATION CONDUIT/WIRING STUBBED OUT WITH END CAP OR INSULATED PLASTIC

Switches and Receptacles

DUPLEX RECEPTACLE

GENERAL ELECTRICAL NOTES

- A. DO NOT COMMENCE INSTALLATION OF ELECTRICAL SYSTEMS AND EQUIPMENT WITHOUT RELATED SHOP DRAWING APPROVALS.
- B. ELECTRICAL CIRCUITS SHALL BE INTERRUPTED ONLY WITH PRIOR WRITTEN CONSENT. SUCH INTERRUPTIONS SHALL BE PRECEDED BY ALL POSSIBLE PREPARATIONS BY THE CONTRACTOR WHICH ARE NECESSARY TO KEEP THE ELECTRICAL CIRCUITS OFF FOR A MINIMUM PERIOD IN AN EXPEDITIOUS MANNER PURSUANT WITH GOOD WORKMANSHIP. THIS INCLUDES CIRCUIT TRACING TO IDENTIFY THE ELECTRICAL LOAD BEING SERVED AND THE ORIGIN OF THE CIRCUIT.
- COORDINATE WITH OWNER SO THAT WORK CAN BE SCHEDULED NOT TO INTERRUPT OPERATIONS, NORMAL ACTIVITIES, BUILDING ACCESS, ACCESS TO DIFFERENT AREAS. THE OWNER WILL COOPERATE TO THE BEST OF THEIR ABILITY TO ASSIST IN A COORDINATED SCHEDULE, BUT WILL REMAIN THE FINAL AUTHORITY AS TO TIME OF WORK PERMITTED.
- D. COORDINATE THE EXACT LOCATION OF EXISTING UTILITIES AND EQUIPMENT PRIOR TO COMMENCEMENT OF WORK. COMPENSATE THE OWNER FOR DAMAGES CAUSED BY THE FAILURE TO LOCATE AND PRESERVE UTILITIES. REPLACE DAMAGED ITEMS WITH NEW MATERIAL TO MATCH EXISTING.
- REMOVE EXISTING LUMINAIRES, SWITCHES, RECEPTACLES, AND OTHER ELECTRICAL EQUIPMENT AND DEVICES AND ASSOCIATED WIRING FROM WALLS, CEILINGS, FLOORS, AND OTHER SURFACES SCHEDULED FOR REMODELING, RELOCATION, OR DEMOLITION UNLESS SHOWN AS RETAINED OR RELOCATED ON
- MAINTAIN ELECTRICAL CONTINUITY OF EXISTING SYSTEMS. REMOVE OR RELOCATE ELECTRICAL BOXES, CONDUIT, WIRING, EQUIPMENT, LUMINAIRES, AND THE LIKE, AS REQUIRED IN REMOVED OR REMODELED AREAS IN THE EXISTING CONSTRUCTION AFFECTED BY THIS WORK.
- G. REMOVE AND RESTORE WIRING WHICH SERVES USABLE EXISTING OUTLETS CLEAR OF THE CONSTRUCTION OR DEMOLITION.
- H. IF EXISTING JUNCTION BOXES WILL BE MADE INACCESSIBLE, OR IF ABANDONED OUTLETS SERVE AS FEED THROUGH BOXES FOR OTHER EXISTING ELECTRICAL EQUIPMENT WHICH IS BEING RETAINED, PROVIDE NEW CONDUIT AND WIRE TO BYPASS THE ABANDONED OUTLETS.
- IF EXISTING CONDUITS PASS THROUGH PARTITIONS OR CEILING WHICH ARE BEING REMOVED OR REMODELED. PROVIDE NEW CONDUIT AND WIRE TO REPOUTE CLEAR OF THE CONSTRUCTION OR DEMOLITION AND MAINTAIN SERVICE TO THE EXISTING LOAD.
- CONCEALED CONDUIT LOCATED IN CONCRETE WALLS OR HARDBOARD CEILING SPACES MAY BE ABANDONED IN PLACE. REMOVE CONDUCTORS AND TAG ABANDONED CONDUITS WITH CORRESPONDING SYSTEM AND TERMINATION POINT. CUT AND CAP ABANDONED CONDUIT. DO NOT EXTEND STUBS ABOVE FINISHED FLOOR.
- K. EXTEND CIRCUITING AND DEVICES IN EXISTING WALLS TO BE FURRED OUT.
- PROVIDE TEMPORARY SUPPORT FOR ELECTRICAL SYSTEMS THAT REMAIN IN PLACE.
- M. VERIFY EXACT LOCATION AND NUMBER OF EXISTING ELECTRICAL OUTLETS AND LUMINAIRES IN THE FIELD. LOCATIONS OF ITEMS SHOWN ON DRAWINGS AS EXISTING ARE PARTIALLY BASED ON RECORD AND OTHER DRAWINGS WHICH MAY CONTAIN ERRORS. VERIFY THE ACCURACY OF THE INFORMATION SHOWN PRIOR TO BIDDING AND PROVIDE SUCH LABOR AND MATERIAL AS IS NECESSARY TO ACCOMPLISH THE INTENT OF THE CONTRACT DOCUMENTS.
- REMOVE ABANDONED WIRING TO LEAVE SITE CLEAN.
- O. EXISTING LIGHTING WHICH IS TO REMAIN OR BE RELOCATED IS TO BE RELAMPED, REBALLASTED, AND CLEANED. LEAVE ALL LUMINAIRES IN PROPER WORKING ORDER. REPLACE DAMAGED OR BROKEN LENS AND/OR COMPONENTS.
- P. MAINTAIN ACCESS TO EXISTING ELECTRICAL INSTALLATIONS WHICH REMAIN ACTIVE. MODIFY INSTALLATION OR PROVIDE ACCESS PANEL AS APPROPRIATE.
- Q. WHERE DRAWINGS INDICATE EXISTING ELECTRICAL EQUIPMENT OR DEVICES TO BE RELOCATED AND/OR REUSED, REFURBISH THEM. THOROUGHLY CLEAN SUCH ITEMS. NOTIFY ARCHITECT OF ANY DEFECTS IN SUCH INSTALLATIONS. REPAIR ANY DAMAGE CAUSED BY DEMOLITION OR CONSTRUCTION PERFORMED UNDER THIS CONTRACT.
- R. PROVIDE UPDATED PANEL SCHEDULES AND DIRECTORIES THAT IDENTIFY EXISTING CIRCUITS AND NUMBER OF SPARE CIRCUITS AVAILABLE UPON COMPLETION OF DEMOLITION WORK.
- S. OFFER REMOVED LUMINAIRES, WIRING DEVICES, PANELBOARDS AND EQUIPMENT TO THE OWNER. IF OWNER CHOOSES TO RETAIN THESE ITEMS, RETURN SUCH ITEMS TO OWNER, CAREFULLY REMOVE AND DISPOSE OF ITEMS REJECTED BY OWNER FROM PROJECT SITE AND IN A LEGAL MANNER.
- T. RECONNECT EXISTING LUMINAIRES NOT SHOWN ON DRAWINGS AND AFFECTED DUE TO DEMOLITION TO NEAREST AVAILABLE EXISTING LIGHTING CIRCUIT ABLE TO TAKE THE ADDITIONAL LOAD.
- U. REFER TO SPECIFICATIONS FOR ADDITIONAL REQUIREMENTS.
- V. DRAWINGS AND SPECIFICATIONS COMPLIMENT EACH OTHER. REQUIREMENT BY EITHER INFERS REQUIREMENT BY BOTH.
- W. CONNECT EQUIPMENT AND DEVICES FURNISHED UNDER OTHER DIVISIONS OF THIS CONTRACT, BY OWNER OR BY OTHER CONTRACTS.
- X. UNLESS OTHERWISE NOTED, PROVIDE CONCEALED AND FLUSH MOUNTED INSTALLATION OF DEVICES AND
- Y. PROVIDE SEPARATE EQUIPMENT GROUNDING CONDUCTOR IN 120 VOLT, MULTI-WIRE CIRCUITS.
- Z. FOR 120 VOLT, 20 AMP CIRCUITS, WHERE CIRCUIT DISTANCE FROM PANELBOARD TO FARTHEST DEVICE/FIXTURE EXCEEDS 75 FEET, PROVIDE #10 SIZE CONDUCTOR.
- AA. RUN ELECTRICAL CONDUIT CONCEALED AND PARALLEL TO BUILDING LINES. VERIFY WITH ARCHITECT.
- AB. RECEPTACLE OUTLETS SHALL COMPLY WITH CEC SECTION 210.7.
- AC. LIGHTS, SWITCHES AND CONTROL MECHANISMS SHALL COMPLY WITH CEC SECTION 404.
- AD. BRACE ELECTRICAL EQUIPMENT TO RESIST A HORIZONTAL FORCE THAT ACT IN ANY DIRECTION. COMPLY WITH TITLE 24 REQUIREMENTS.
- AE. INSTALL COMPLETE SYSTEM OF CONDUCTORS IN RACEWAY SYSTEM THROUGHOUT BUILDING FOR FEEDERS, BRANCH CIRCUITS, ETC.

SHEET INDEX

- E0.1 SYMBOL LIST AND GENERAL NOTES ELECTRICAL
- E2.1 FLOOR PLAN LIGHTING
- E2.2 LIGHTING CONTROL FLOOR PLANS



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REVISIONS

SHEET TITLE THEATER HOUSE LIGHTING RETROFIT SYMBOL LIST AND **GENERAL NOTES** - ELECTRICAL

SCALE: NO SCALE DATE: Sept. 9, 2014



- A. COORDINATE EXACT LOCATION AND MOUNTING HEIGHT OF LUMINAIRES AND LIGHTING CONTROLS WITH THEATRICAL LIGHTING CONSULTANT PRIOR TO
- B. REFER TO THEATRICAL LIGHTING CONSULTANT DRAWINGS FOR ADDITIONAL INFORMATION AND LIGHTING CONTROL REQUIREMENTS.
- C. REFER TO THEATRICAL LIGHTING CONSULTANT DRAWINGS FOR LUMINAIRE SCHEDULE AND SYMBOLS.
- D. EXISTING LUMINAIRES AND LIGHTING CONTROLS NOT SHOWN ON PLAN SHALL REMAIN, U.O.N.

○ SHEET KEYNOTES

1 DISCONNECT AND REUSE EXISTING LIGHTING CIRCUIT AS PART OF LED LUMINAIRE REPLACEMENT. LUMINAIRES TO BE RECONNECTED BACK TO EXISTING DIMMER

REVISIONS

SHEET TITLE
THEATER HOUSE
LIGHTING RETROFIT
FLOOR PLAN LIGHTING

SCALE: AS NOTED DATE: Sept. 9, 2014

E2.1


- A. COORDINATE EXACT LOCATION AND MOUNTING HEIGHT OF EQUIPMENTS AND LIGHTING CONTROLS WITH THEATRICAL LIGHTING CONSULTANT PRIOR TO INSTALLATION.
- B. REFER TO THEATRICAL LIGHTING CONSULTANT DRAWINGS FOR ADDITIONAL INFORMATION AND LIGHTING CONTROL REQUIREMENTS.
- C. EXISTING EQUIPMENTS AND LIGHTING CONTROLS NOT SHOWN ON PLAN SHALL REMAIN, U.O.N.


○ SHEET KEYNOTES


- 1 DISCONNECT AND REMOVE EXISTING UNISON SINGLE-GANG 10-BUTTON SNAPSHOT STATION AND REPLACE WITH NEW STATION 'S'. RECONNECT COMPLETE BACK TO EXISTING CIRCUIT TO PLACE BACK INTO SERVICE.
- 2 DISCONNECT AND REMOVE EXISTING UNISON SINGLE-GANG 5-BUTTON HOUSE/WORKLIGHT STATION AND REPLACE WITH NEW STATION 'HL'. RECONNECT COMPLETE BACK TO EXISTING CIRCUIT TO PLACE BACK INTO SERVICE.
- 3 DISCONNECT AND REMOVE EXISTING HOUSE LIGHT KEYSWITCH CONTROL STATION AND REPLACE WITH NEW STATION 'HLK'. RECONNECT COMPLETE BACK TO EXISTING CIRCUIT TO PLACE BACK INTO SERVICE.
- 4 EXISTING ETC UNISON ER-4 DR12 WALL MOUNTED DIMMER RACK TO REMAIN.
- INSTALL NEW ETC UNISON PARADIGM ERn2 SIGNAL PROCESSOR RACK WITH SMALL 4-PORT NETWORK SWITCH. INTERCEPT AND EXTEND EXISTING CIRCUIT '3RBB-1.'
 TO NEW RACK AND CONNECT COMPLETE AS REQUIRED TO PLACE INTO SERVICE.





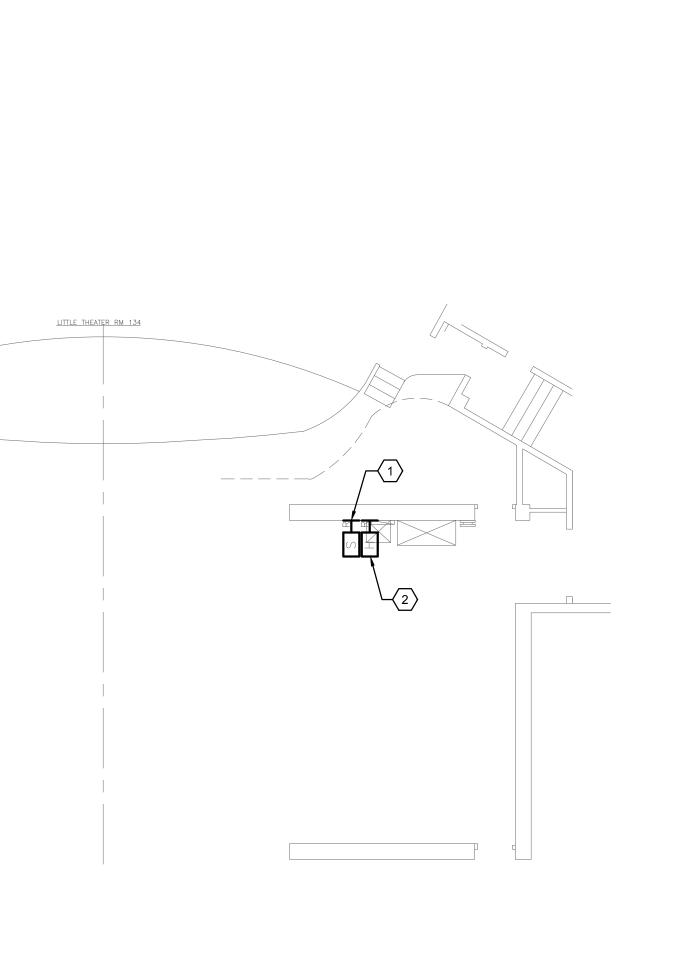


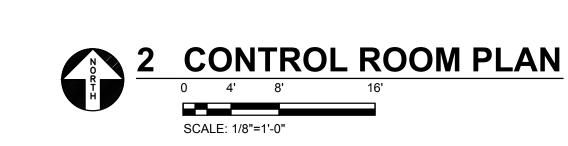

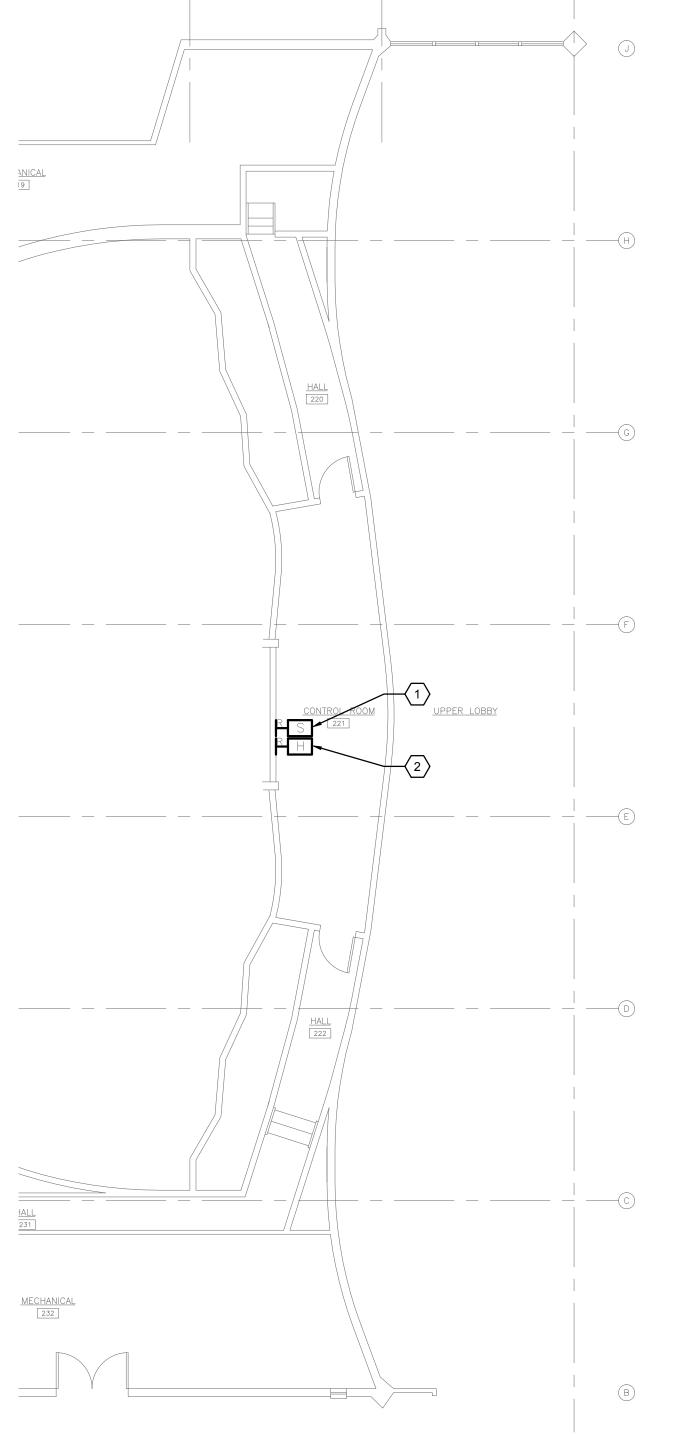





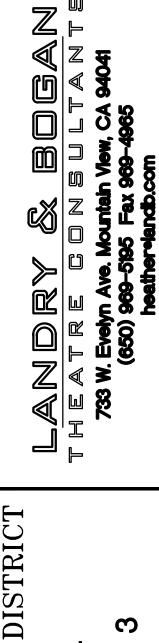

CAÑADA/COLLEGE OF SAN MATEO
HEATER HOUSE LIGHTING RETROFIT
OLLEGE OF SAN MATEO - BUILDING 3

REVISIONS

SHEET TITLE
THEATER HOUSE
LIGHTING RETROFIT
LIGHTING CONTROL
FLOOR PLANS


SCALE: AS NOTED DATE: Sept. 9, 2014

E2.2



SCALE: 1/8"=1'-0"

SCALE: 1/4"=1'-0"

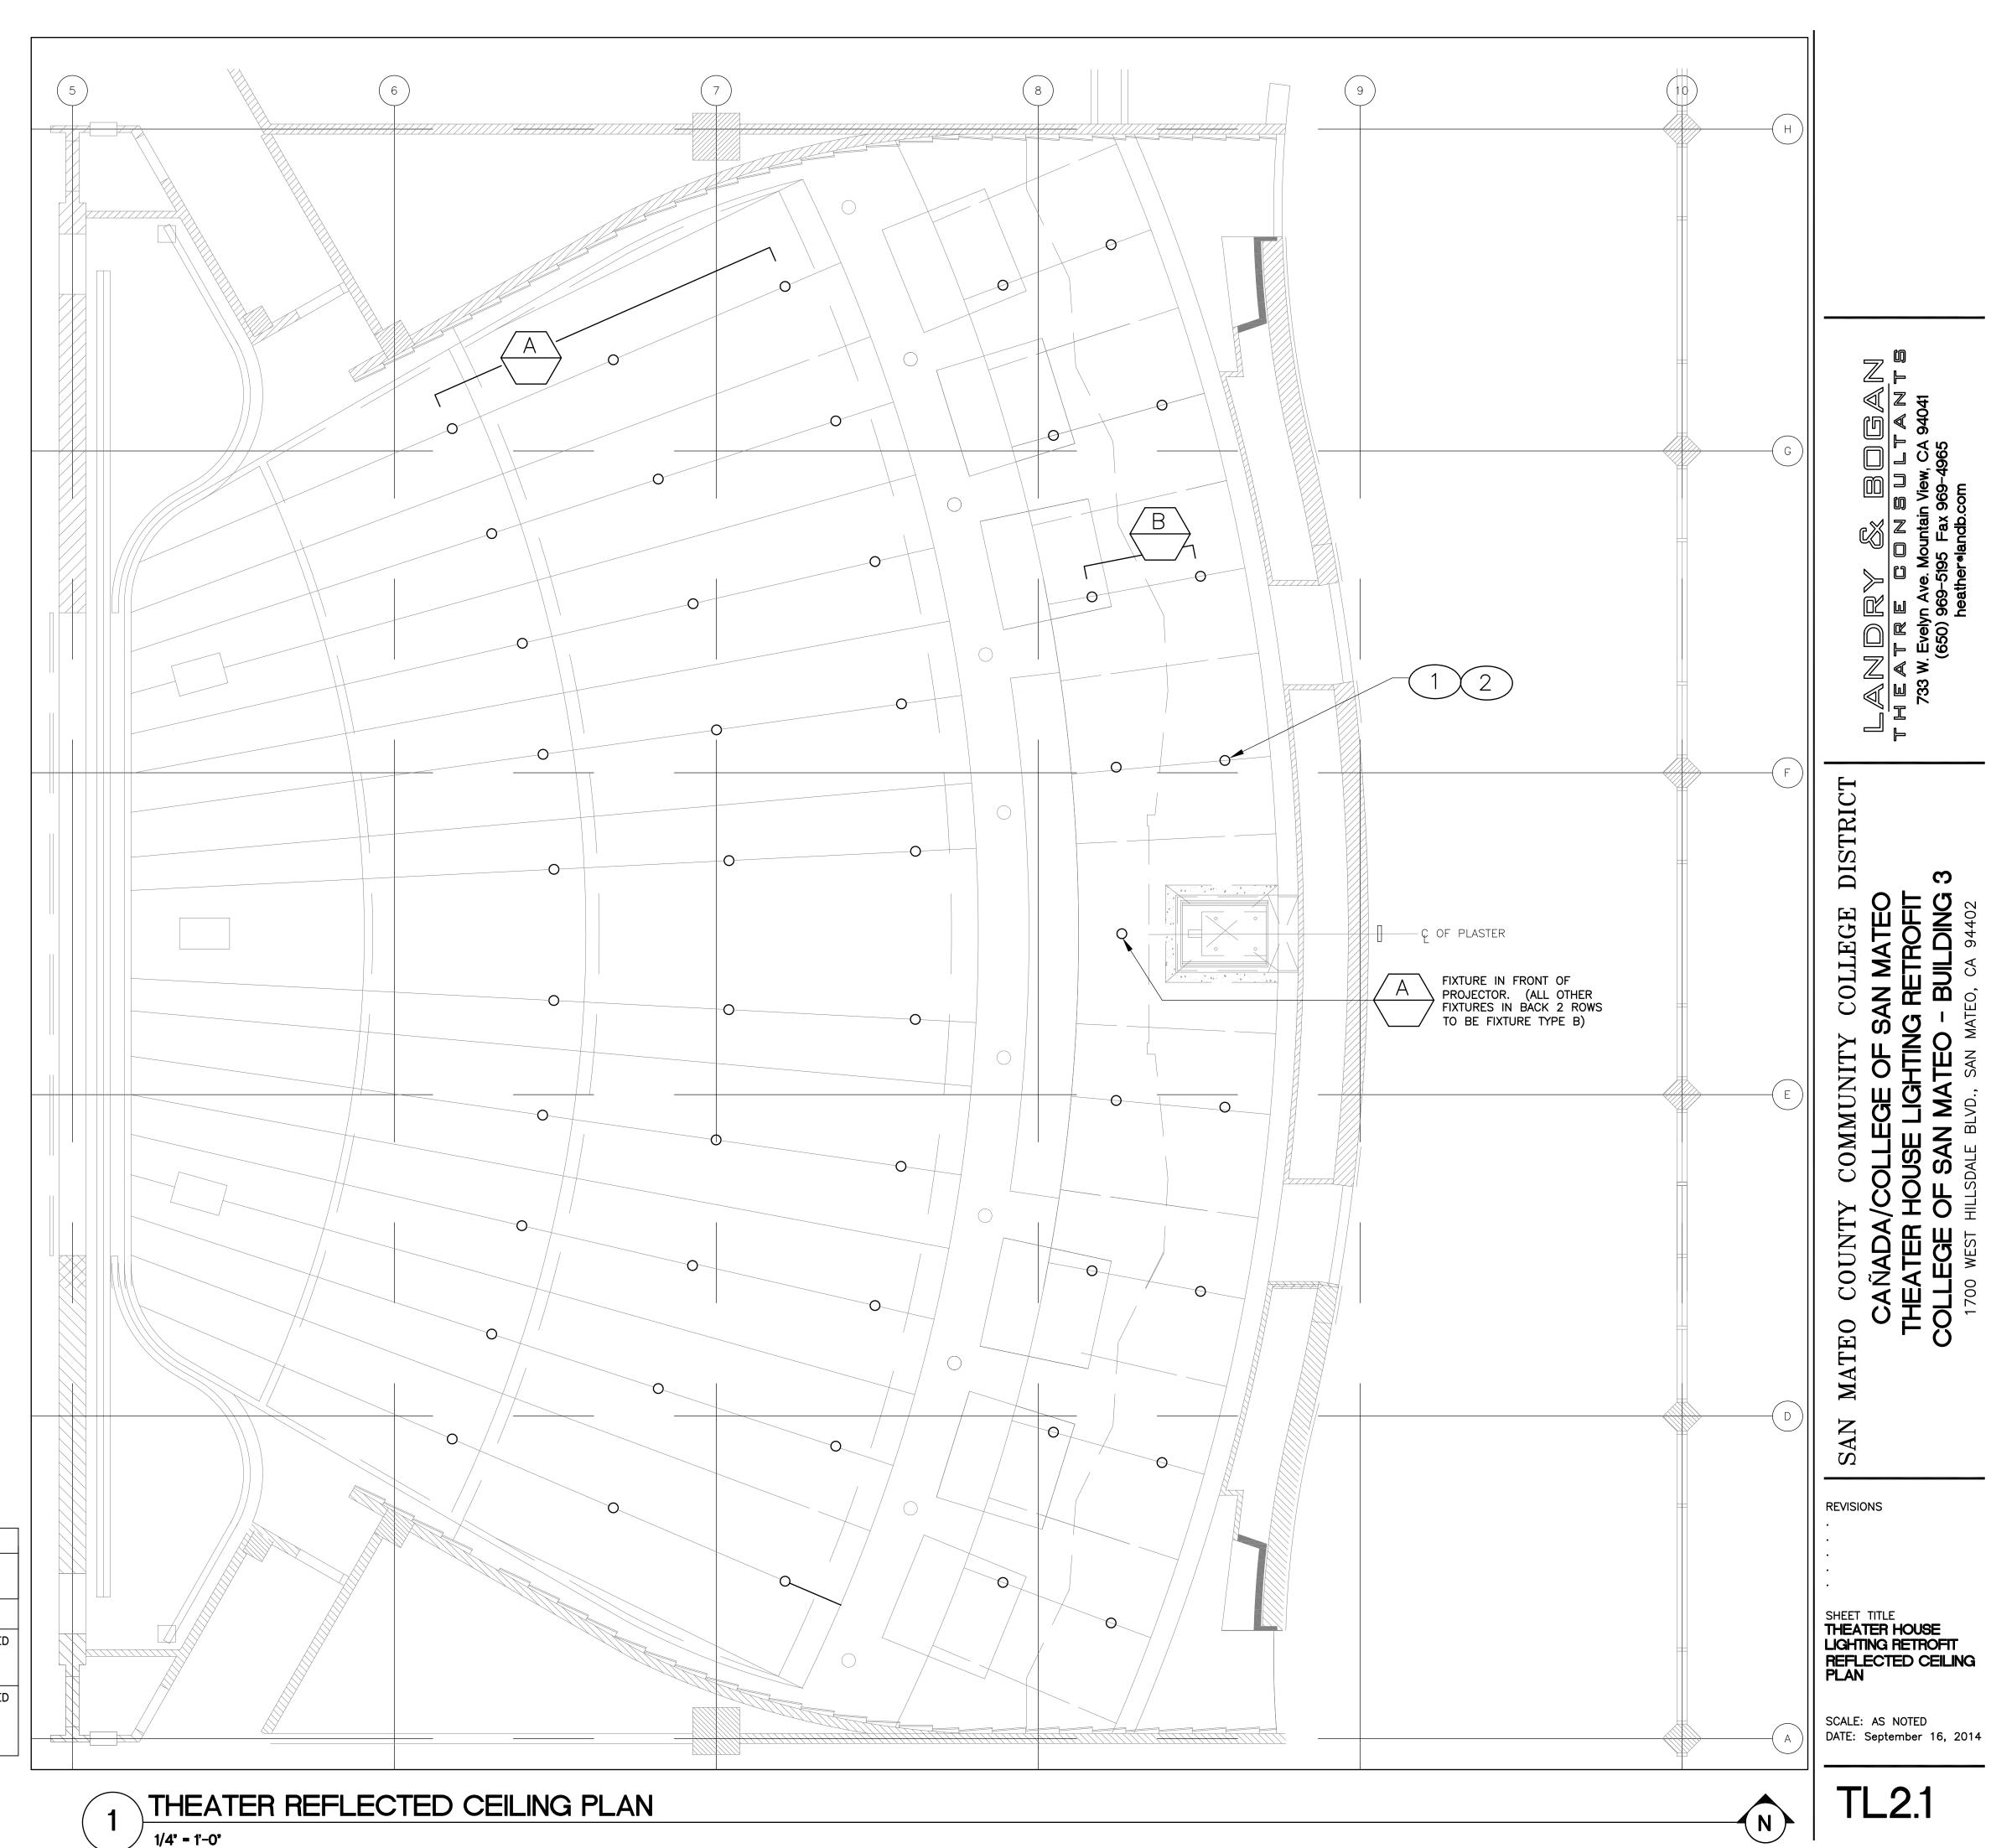

SHEET NOTES

- 1 PROVIDE DMX JUMPERS TO DAISY CHAIN DMX SIGNAL FROM FIXTURE TO FIXTURE FOR FIXTURES TYPE A & B. MAXIMUM NUMBER OF FIXTURES PER RUN IS 32. EXTEND DMX FROM NEW ETC 4-PORT NET 3 GATEWAY LOCATED IN ATTIC (EXACT LOCATION TBD)
- DISCONNECT AND REMOVE EXISTING
 INCANDESCENT DOWNLIGHT FIXTURES AND
 DISPOSE OF AS DIRECTED BY OWNER.
 EXISTING APERTURES WILL BE REUSED FOR INSTALLATION OF NEW TYPE A & B
 FIXTURES. INSTALL NEW TYPE A & B
 FIXTURES INTO EXISTING OPENINGS.
 CONNECT POWER SUPPLIES OF TYPE A & B
 FIXTURES TO EXISTING HOME—RUNS TO
 EXISTING ETC DR12 DIMMER RACK.

<u>SYMBOL</u> **DESCRIPTION** Fixture type (see schedule for details) Down light luminaire, ceiling mounted in existing opening. \Box

Existing Snapshot Control Station


Existing House Light Control Station

SCHEDULE OF LIGHTING FIXTURES

REFER TO ARCHITECTURAL DETAILS TO DETERMINE NECESSARY FIXTURE MOUNTING ACCESSORIES AND TO APPLICABLE BUILDING CODES FOR REQUIRED FIXTURE SUPPORTS, AND FOR MAINTAINING CEILING FIRE RATINGS.

 \Box

TYPE		FIXTURE DESCRIPTION	MFR'S CATALOG NO.	MOUNTING	VOLTAGE	LAMPS/WATTAGE
	A	RECESSED LED DOWNLIGHT, 2700 KELVIN, 2000 LUMENS, 45 DEGREE BEAM ANGLE, DMX-RDM CONTROLLED.	GOTHAM ICO 27/20 6AR 45 120 DMXR, NPP16D	RECESSED HT. AS NOTED	120	2700K WHITE LED 35 WATTS
	B	RECESSED LED DOWNLIGHT, 2700 KELVIN, 2000 LUMENS, 70 DEGREE BEAM ANGLE, DMX-RDM CONTROLLED.	GOTHAM ICO 27/20 6AR 70 120 DMX5, NPP16D	RECESSED HT. AS NOTED	120	2700K WHITE LED 35 WATTS

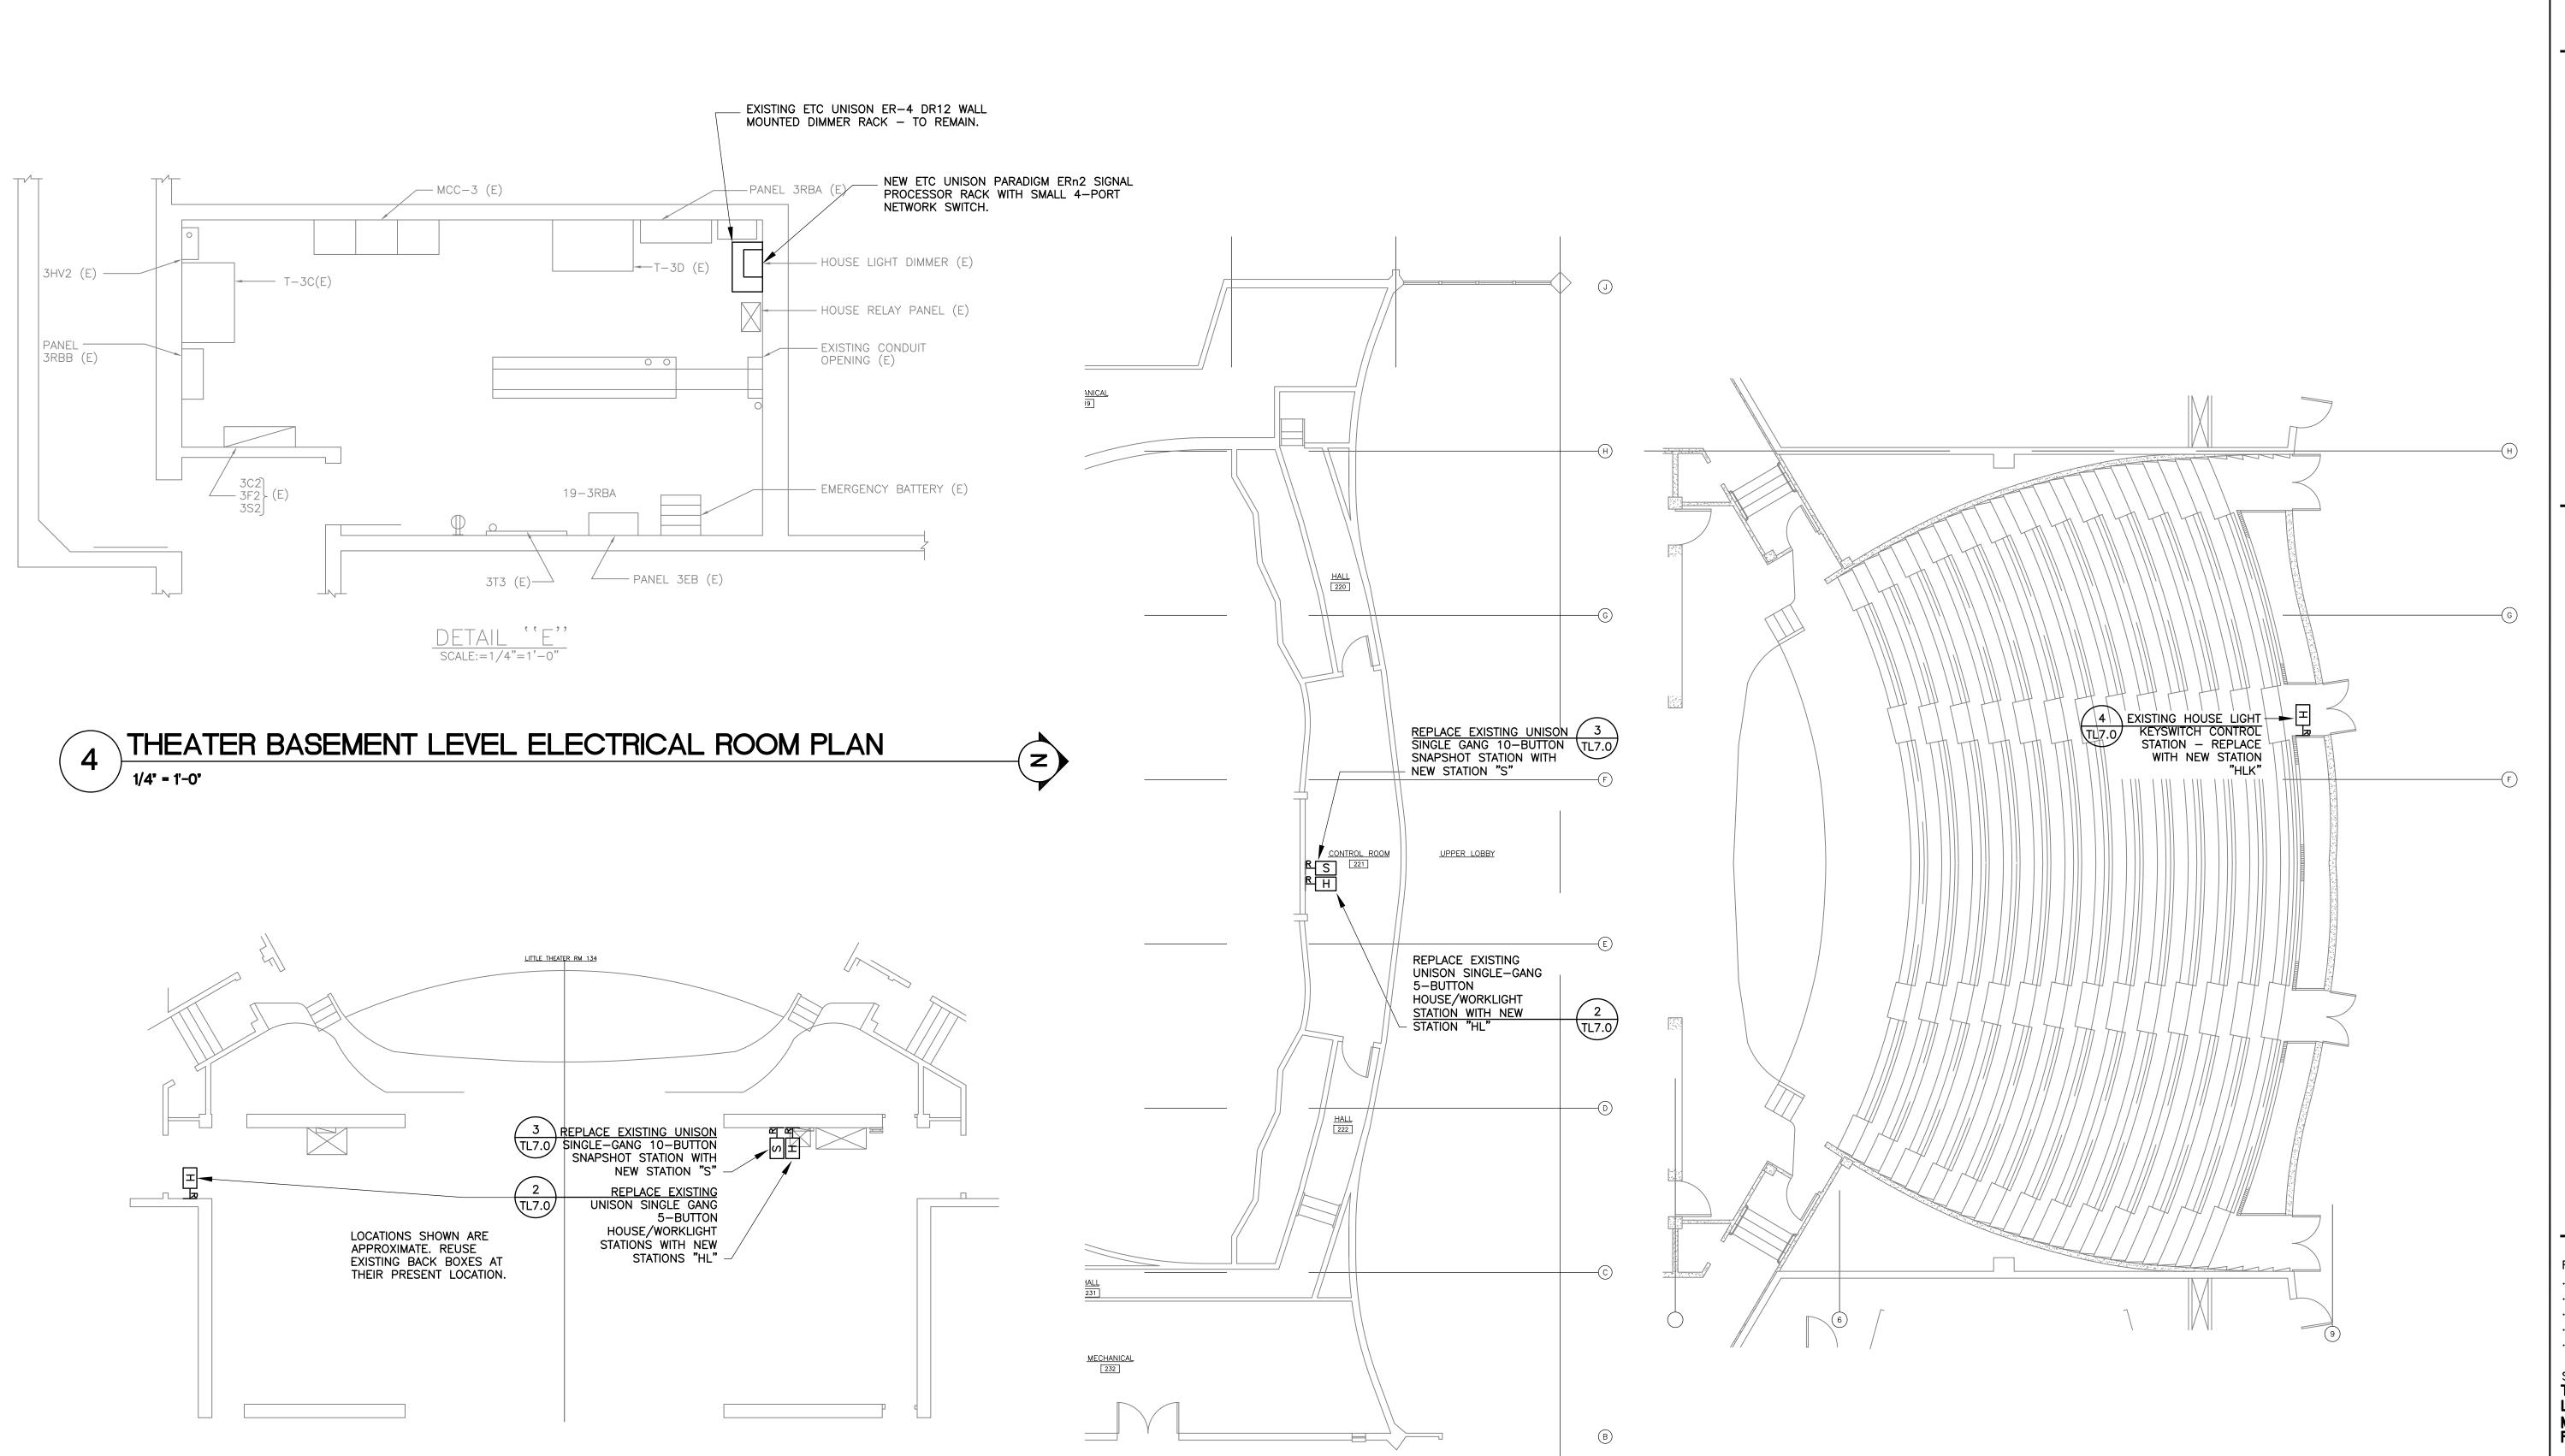

CONTROL ROOM PLAN
1/8' - 1'-0'

THEATER MAIN LEVEL STAGE PLAN

LANDRY & BULTANTS HEATRE GONSW, CA 94041 (650) 969-5195 Fax 969-4965

NULLEGE DISTRICT
NATEO

LANGE

LANGE

THEAT

733 W. EV

(65)

MATEO COUNTY COMMUNITY COLLEGE DIS CAÑADA/COLLEGE OF SAN MATEO THEATER HOUSE LIGHTING RETROFIT COLLEGE OF SAN MATEO - BUILDING 3

| SAN


REVISIONS .

SHEET TITLE
THEATER HOUSE
LIGHTING RETROFIT
MAIN LEVEL
PLAN

SCALE: AS NOTED
DATE: September 16, 2014

TL2.2

THEATER MAIN LEVEL AUDITORIUM PLAN

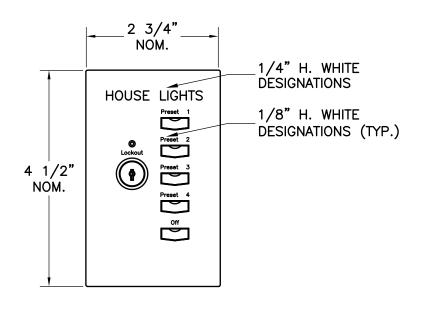

STEEL OR ALUMINUM FACEPLATE W/BLACK SEMI-GLOSS FINISH AND WHITE DESIGNATIONS. FACE PLATE REMOVABLE FOR ACCESS.

MOUNT ON EXISTING SINGLE-GANG BACK BOX

6" = 1'-0"

HOUSELIGHT KEYSWITCH STATION "HLK"

NOM.

1/4" H. WHITE
DESIGNATIONS

1/8" H. WHITE
DESIGNATIONS (TYP.)

4 1/2"
NOM.


Preset 3
Preset 4
Preset 4
Preset 5
Off
LED 50% RED IN OFF (PILOT LIGHT) MODE
LED 100% GREEN IN ON MODE

STEEL OR ALUMINUM FACEPLATE W/BLACK SEMI-GLOSS FINISH AND WHITE DESIGNATIONS. FACE PLATE REMOVABLE FOR ACCESS.

MOUNT ON EXISTING SINGLE GANG BACK BOX.

ON/OFF BUTTON (TYPICAL)


3 SNAPSHOT STATION "S"

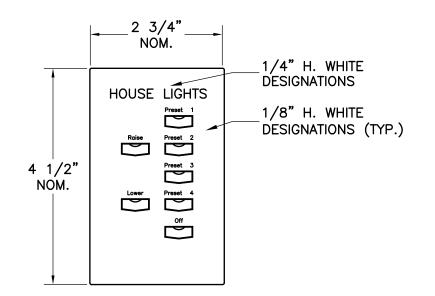

STEEL OR ALUMINUM FACEPLATE W/BLACK SEMI-GLOSS FINISH AND WHITE DESIGNATIONS. FACE PLATE REMOVABLE FOR ACCESS.

MOUNT ON EXISTING SINGLE-GANG BACK BOX.

PHOUSE LIGHT STATION "HL"

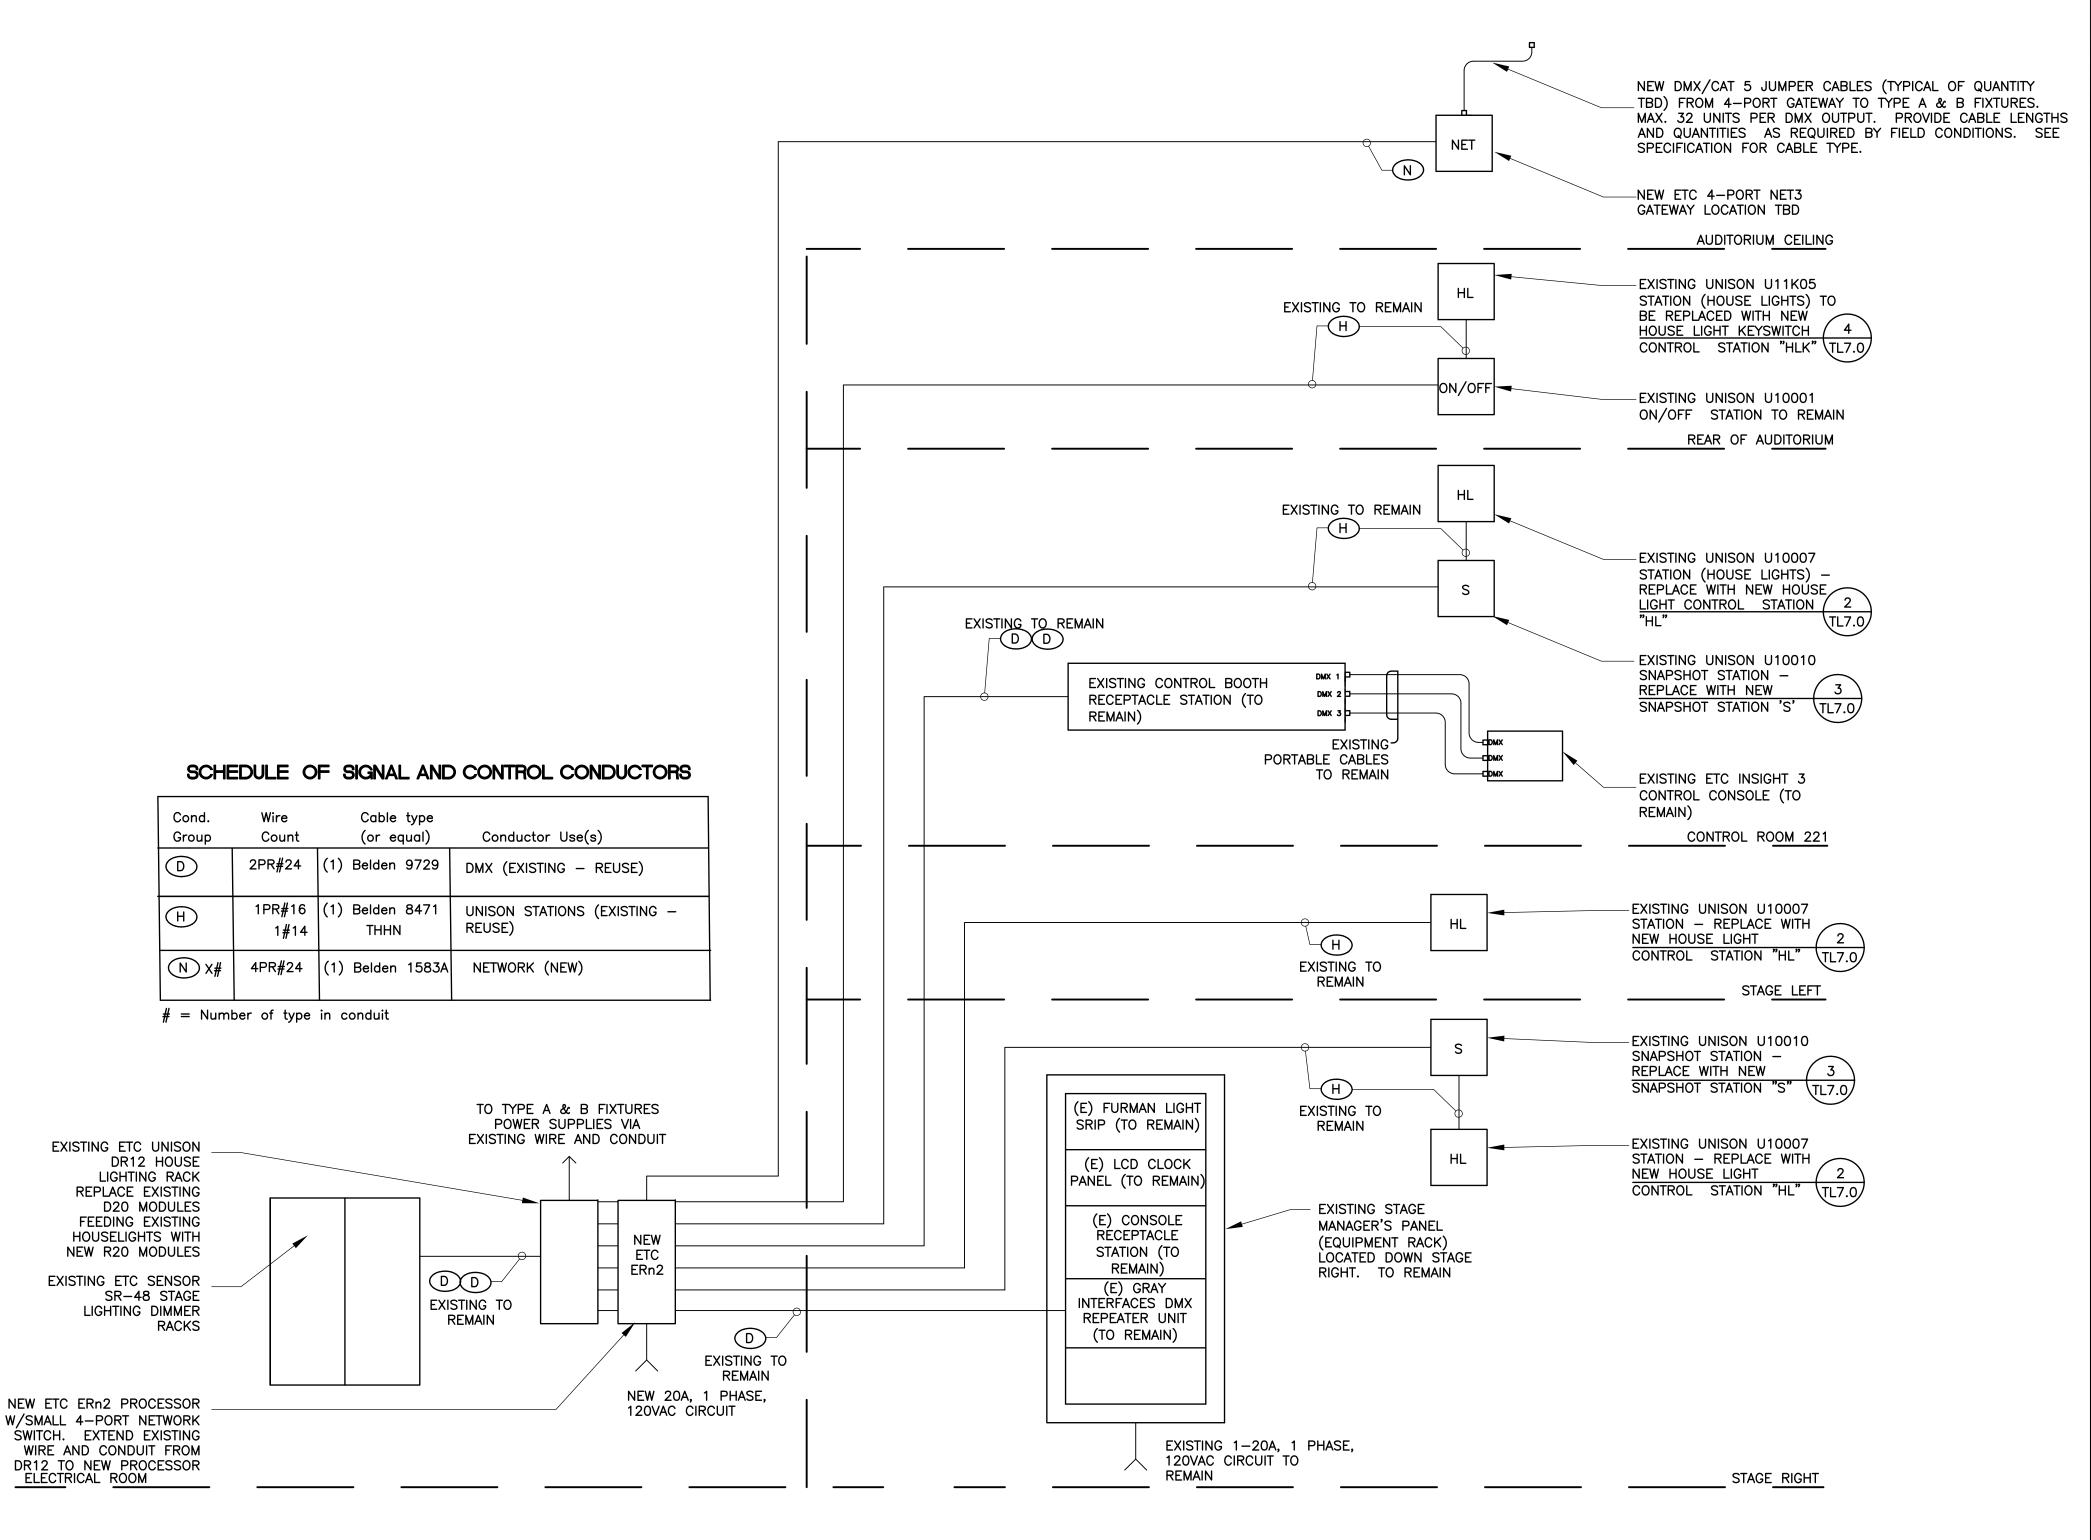

THEATRE SYSTEM SIGNAL AND CONTROL RISER DIAGRAM

NOTES: 1. ALL NEW SIGNAL & CONTROL CONDUIT TO BE 3/4" U.N.O.
2. TYPES AND QUANTITIES OF SIGNAL & CONTROL CONDUCTORS ARE APPROXIMATE. ACTUAL TYPES & QUANTITES TO BE AS RECOMMENDED BY STAGE LIGHTING EQUIPMENT MANUFACTURER.

TL7.0

DATE: September 16, 2014

DISTRICT

COLI

COMMUNITY

MATEO

SAN

REVISIONS

SHEET TITLE

THEATER HOUSE

RISER DIAGRAM + DETAILS

SCALE: AS NOTED

LIGHTING RETROFIT

EGE OF SA LIGHTING | MATEO -BLVD., SAN MATE

CANADA/C
CANADA/C
THEATER HC
COLLEGE OF